

ELEVATOR & ESCALATOR MODERNIZATION AND SERVICE

AT THE

NEW HAVEN PARKING AUTHORITY FACILITIES

NEW HAVEN, CONNECTICUT JULY 2025 N.H.P.A. PROJECT # 21-011

CONTRACTING AGENCY: NEW HAVEN PARKING AUTHORITY



c/o DEPARTMENT OF PLANNING & ENGINEERING TEMPLE STREET PARKING GARAGE ONE TEMPLE STREET NEW HAVEN, CONNECTICUT 06510 Tel. (203) 946-7526

STRUCTURAL ENGINEER / ARCHITECT: DESMAN

175 CAPITAL BOULEVARD, SUITE 402

ELEVATOR CONSULTANT: STERLING ELEVATOR CONSULTANTS, LLC

STERLING

AVON, CT 06001 Tel. (800) 209-9909

ARCHITECT: SVIGALS + PARTNERS

SVIGALS + PARTNERS NEW HAVEN, CT 06510
Tel. (203) 786-5110

ELEC/MECH ENGINEERS: SILVER/PETRUCELLI & ASSOCIATES

ILVER/PETRUCELLI+ASSOCIATES Architects / Engineers / Interior Designers

HAMDEN, CONNECTICUT 06518-2340

SCOPE OF WORK

Proposal Item 1 - General Provisions

Parking Garage:

AIR RIGHTS

- A. GeneralMobilization/Demobilization/Miscellaneous Coordination
- B. Provision of Bonds, Permits, and Insurance.

Proposal Item 2 - Work related to the 270 State Street Parking

- A. Modernization of the Hydraulic Elevators at the 270 State
- Street Parking Garage. B. Electrical Coordination Work to Support the Elevator Repairs
- and Modernization at the 270 State Street Parking Garage. C. HVAC/Mechanical Improvements at the 270 State Street

Proposal Item 3 - Work related to the Temple Medical Parking Garage:

- A. Modernization of the Hydraulic Elevators at the Temple Medical Parking Garage.
- B. Electrical Coordination Work to Support Elevator Repairs and Modernization at the Temple Medical Parking Garage.
- C. HVAC/Mechanical Improvements at the Temple Medical Parking Garage:
- D. Architectural Repairs and Improvements:
- 1. Installation of Epoxy Flooring:
- a. Provision and Installation of Mock-up Sample.
- b. Installation of Flooring System throughout the **Elevator Lobbies**
- c. Installation of New Tactile Warning Surfaces.

Installation of Exterior Insulation and Finish System

- (EIFS) related to the Vinyl Wall Coverings Installation of Vinyl Wall Coverings/Murals and
- Window Film
- 4. Installation of New Signage
- 5. Installation of Precast Bollards 6. Modifications to Concrete Curbing
- 7. Painting of Various Surfaces
- 8. Miscellaneous Metal Work

Proposal Item 4 - Work related to the Temple Street Parking Garage:

- A. Modernization of the Hydraulic Elevators at the Temple
- Street Parking Garage. B. Modernization of the Traction Elevators at the Temple Street Parking Garage.
- C. Electrical Coordination Work to Support Elevator Repairs and Modernization at the Temple Street Parking Garage. D. HVAC/Mechanical Improvements at the Temple Street

Proposal Item 5 - Work related to the Air Rights Parking Garage:

- A. Modernization of the Traction Elevators at the Air Rights Parking Garage.
- B. Electrical Coordination Work to Support Elevator Repairs and Modernization at the Air Rights Parking Garage.
- C. HVAC Improvements at the Air Rights Parking Garage:

Parking Garage:

DRAWING INDEX

COVER SHEET CS-1.0

CS-1.1 SITE PLANS

CS-1.2

TS-M-1

SITE PLANS

TM-T1.01 DRAWING LIST, NOTES, ABBREVIATIONS & FINISH

- LEGEND
- TM-D1.01 DEMOLITION FLOOR PLANS
- TM-A1.01 LEVEL 1 FLOOR PLANS
- LEVEL 2 FLOOR PLANS TM-A1.02
- LEVEL 3 FLOOR PLANS TM-A1.03
- TM-A1.04 LEVEL 4 FLOOR PLANS
- TM-E-1 ELECTRICAL PART PLANS ELECTRICAL LEGEND. DETAIL AND GEN. NOTES TM-E-2
- TM-M-1BASEMENT FLOOR EMR PLANS

AR-E-1 ELECTRICAL DEMOLITION PART PLANS

- AR-E-2 ELECTRICAL NEW WORK PART PLANS
- AR-E-3 ELECTRICAL LEGEND, DETAIL AND GEN. NOTES
- AR-M-1 ROOF EMR PLANS

SS-E-1 ELECTRICAL PART PLANS

- SS-E-2 FIRE ALARM PLANS
- SS-E-3 ELECTRICAL LEGEND, DETAIL AND GEN. NOTES
- GROUND FLOOR EMR PLANS SS-M-1

TS-E-1 ELECTRICAL DEMOLITION PART PLANS

- TS-E-2 ELECTRICAL NEW WORK PART PLANS
- TS-E-3 ELECTRICAL LEGEND, DETAIL AND GEN. NOTES

GROUND FLOOR AND ROOF EMR PLANS

- 11. ANY UTILITY LINES ABANDONED OR NO LONGER IN SERVICE THAT WOULD INTERFERE WITH THE PROJECT SHALL BE IDENTIFIED BY THE CONTRACTOR AND REMOVED FROM THE REPAIR AREAS BY THE CONTRACTOR, UNLESS NOTED OTHERWISE, PRIOR TO START OF WORK.
- 12. ALL DETAILS, SECTIONS AND NOTES SHOWN ON THE DRAWINGS ARE INTENDED TO BE TYPICAL AND SHALL APPLY TO SIMILAR SITUATIONS ELSEWHERE, UNLESS OTHERWISE SHOWN.
- 13. THE CONTRACTOR SHALL PROVIDE THE ENGINEER/OWNER A COMPREHENSIVE TRAFFIC CONTROL PLAN PRIOR TO STARTING WORK. CONTRACTOR SHALL BE RESPONSIBLE FOR OBTAINING ANY NECESSARY PERMITS AS WELL AS FOR THE PROVISION OF ALL REQUIRED TRAFFIC CONTROL DEVICES, WARNING LIGHTS AND SIGNAGE IN ACCORDANCE WITH THE CURRENT EDITION OF THE AASHTO MANUAL ON UNIFORM TRAFFIC CONTROL DEVICES. CONTRACTOR SHALL ALSO PROVIDE EXTRA-DUTY POLICE OFFICERS TO DIRECT TRAFFIC AS MAY BE REQUIRED BY OBSTRUCTION PERMITS.

GENERAL NOTES

- 2. CONTRACTOR IS INSTRUCTED NOT TO SCALE DRAWINGS
- COMMENCING WORK
- THE CHANGES, AND FURTHER ACTION IF AND AS REQUIRED
- 5. THE CONTRACTOR SHALL PROVIDE AND IMPLEMENT ALL NECESSARY STAGING PLANS SHOWING METHODS AND EQUIPMENT FOR PROTECTING THE GENERAL PUBLIC, GARAGE, ADJACENT BUILDINGS AND LOTS, EQUIPMENT, MATERIALS AND PERSONNEL FROM FIRE AND OTHER DAMAGES. THESE MEASURES SHALL BE IN PLACE PRIOR TO START OF WORK. METHODS AND EQUIPMENT SHOWN IN THE STAGING PLANS ARE SUBJECT TO APPROVAL BY AUTHORITIES HAVING JURISDICTION PRIOR TO ISSUANCE OF THE BUILDING PERMIT. FIRE PROTECTION AND PREVENTION DURING THE CONSTRUCTION PERIOD SHALL BE IN ACCORDANCE WITH ALL LAWS AND REGULATIONS INCLUDING, BUT NOT LIMITED TO, THE LATEST N.F.P.A. REGULATIONS, OSHA REGULATIONS, OSHA REQUIREMENTS, THE STATE OF CONNECTICUT AND THE CITY OF NEW HAVEN REGULATIONS AND ORDINANCES.
- THE CONTRACTOR SHALL COMPLY WITH ALL SAFETY AND HEALTH LAWS AND REGULATIONS INCLUDING, BUT NOT LIMITED TO, THE PROVISIONS AND REQUIREMENTS OF THE OCCUPATIONAL SAFETY AND HEALTH ACT OF 1970 (AS AMENDED) OR THE CONSTRUCTION SAFETY ACT OF 1969 (AS AMENDED); WHICHEVER IS APPLICABLE. THE CONTRACTOR SHALL COMPLY WITH ALL THE MOST RECENT APPLICABLE LAWS, ORDINANCES, RULES, REGULATIONS AND ORDERS OF ANY PUBLIC AUTHORITY HAVING JURISDICTION OVER THE PROJECT IN ORDER TO PROTECT PERSONS AND/ OR PROPERTY FROM DAMAGE, INJURY OR LOSS. THE CONTRACTOR SHALL ERECT AND MAINTAIN, AS REQUIRED BY EXISTING CONDITIONS AND PROGRESS OF THE WORK, ALL REASONABLE SAFEGUARDS FOR SAFETY AND PROTECTION; INCLUDING POSTING DANGER SIGNS AND OTHER WARNINGS AGAINST HAZARDS, PROMULGATING SAFETY REGULATIONS AND NOTIFYING THE OWNER, TENANTS, PATRONS AND USERS OF ADJACENT FACILITIES. THE CONTRACTOR SHALL ALSO ASSURE THAT ALL HIS SUBCONTRACTORS CONFORM TO ALL HEALTH AND SAFETY LAWS AND REGULATIONS.
- THE CONTRACTOR SHALL PROVIDE ALL SHORING, BRACING AND SHEETING REQUIRED FOR SAFETY AND PROPER EXECUTION OF THE WORK. CONTRACTOR IS RESPONSIBLE FOR PREPARATION OF SHOP DRAWINGS, DESIGNED AND STAMPED BY A PROFESSIONAL ENGINEER REGISTERED IN THE STATE CONNECTICUT, FOR ANY SPECIALIZED SHORING, ETC. WHICH MAY BE REQUIRED. DRAWINGS SHALL BE SUBMITTED TO THE ENGINEER AND THE CITY OF NEW HAVEN BUILDING DEPARTMENT FOR APPROVAL.
- WHEN PLANS AND SPECIFICATIONS INCLUDE INFORMATION PERTAINING TO SURFACE OBSERVATIONS, MATERIAL TESTING AND OTHER PRELIMINARY NO RESPONSIBILITY WHATSOEVER WITH RESPECT OF THE SUFFICIENCY OR ACCURACY OF THE INFORMATION, AND THERE IS NO GUARANTEE, EITHER EXPRESSED OR IMPLIED, THAT THE CONDITIONS INDICATED ARE REPRESENTATIVE OF THOSE EXISTING THROUGHOUT THE WORK, OR THAT UNANTICIPATED DEVELOPMENTS MAY NOT OCCUR AND/OR EXIST.
- 9. ANY EXTRA WORK BEYOND THE SCHEDULED QUANTITIES REQUIRING EXTRA COST TO THE OWNER SHALL BE APPROVED BY THE OWNER PRIOR TO COMMENCING SAID WORK. CLAIMS FOR EXTRA WORK WHICH HAVE NOT BEEN AUTHORIZED IN WRITING BY THE OWNER AND APPROVED BY THE ENGINEER WILL BE REJECTED AND THE CONTRACTOR SHALL NOT BE ENTITLED TO PAYMENT.
- 10. THE CONTRACTOR SHALL REVIEW ALL EXISTING CONDITIONS TO DETERMINE ALL SERVICES WHICH MIGHT BE AFFECTED BY THE WORK. THE CONTRACTOR SHALL MAKE NECESSARY TEMPORARY CONNECTIONS TO MAINTAIN EXISTING SERVICES TO ALL AREAS OF THE BUILDING OR OTHER AREAS NOT IN THE CONTRACT AFFECTED BY THE WORK. UPON COMPLETION OF REPAIRS THE CONTRACTOR SHALL MAKE PERMANENT CONNECTIONS TO ALL SERVICES WHICH HAD BEEN TEMPORARILY MAINTAINED.
- 14. THE CONTRACTOR SHALL REMOVE ALL DEBRIS FROM THE SITE ON A DAILY BASIS AND PROTECT MATERIALS AND WORK IN PROGRESS FROM VANDALISM

ISSUED FOR PROPOSALS 7/21/2025

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NO. DATE BY

REVISIONS DRAWING TITLE


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DRAWING NO. **CS-1.0**


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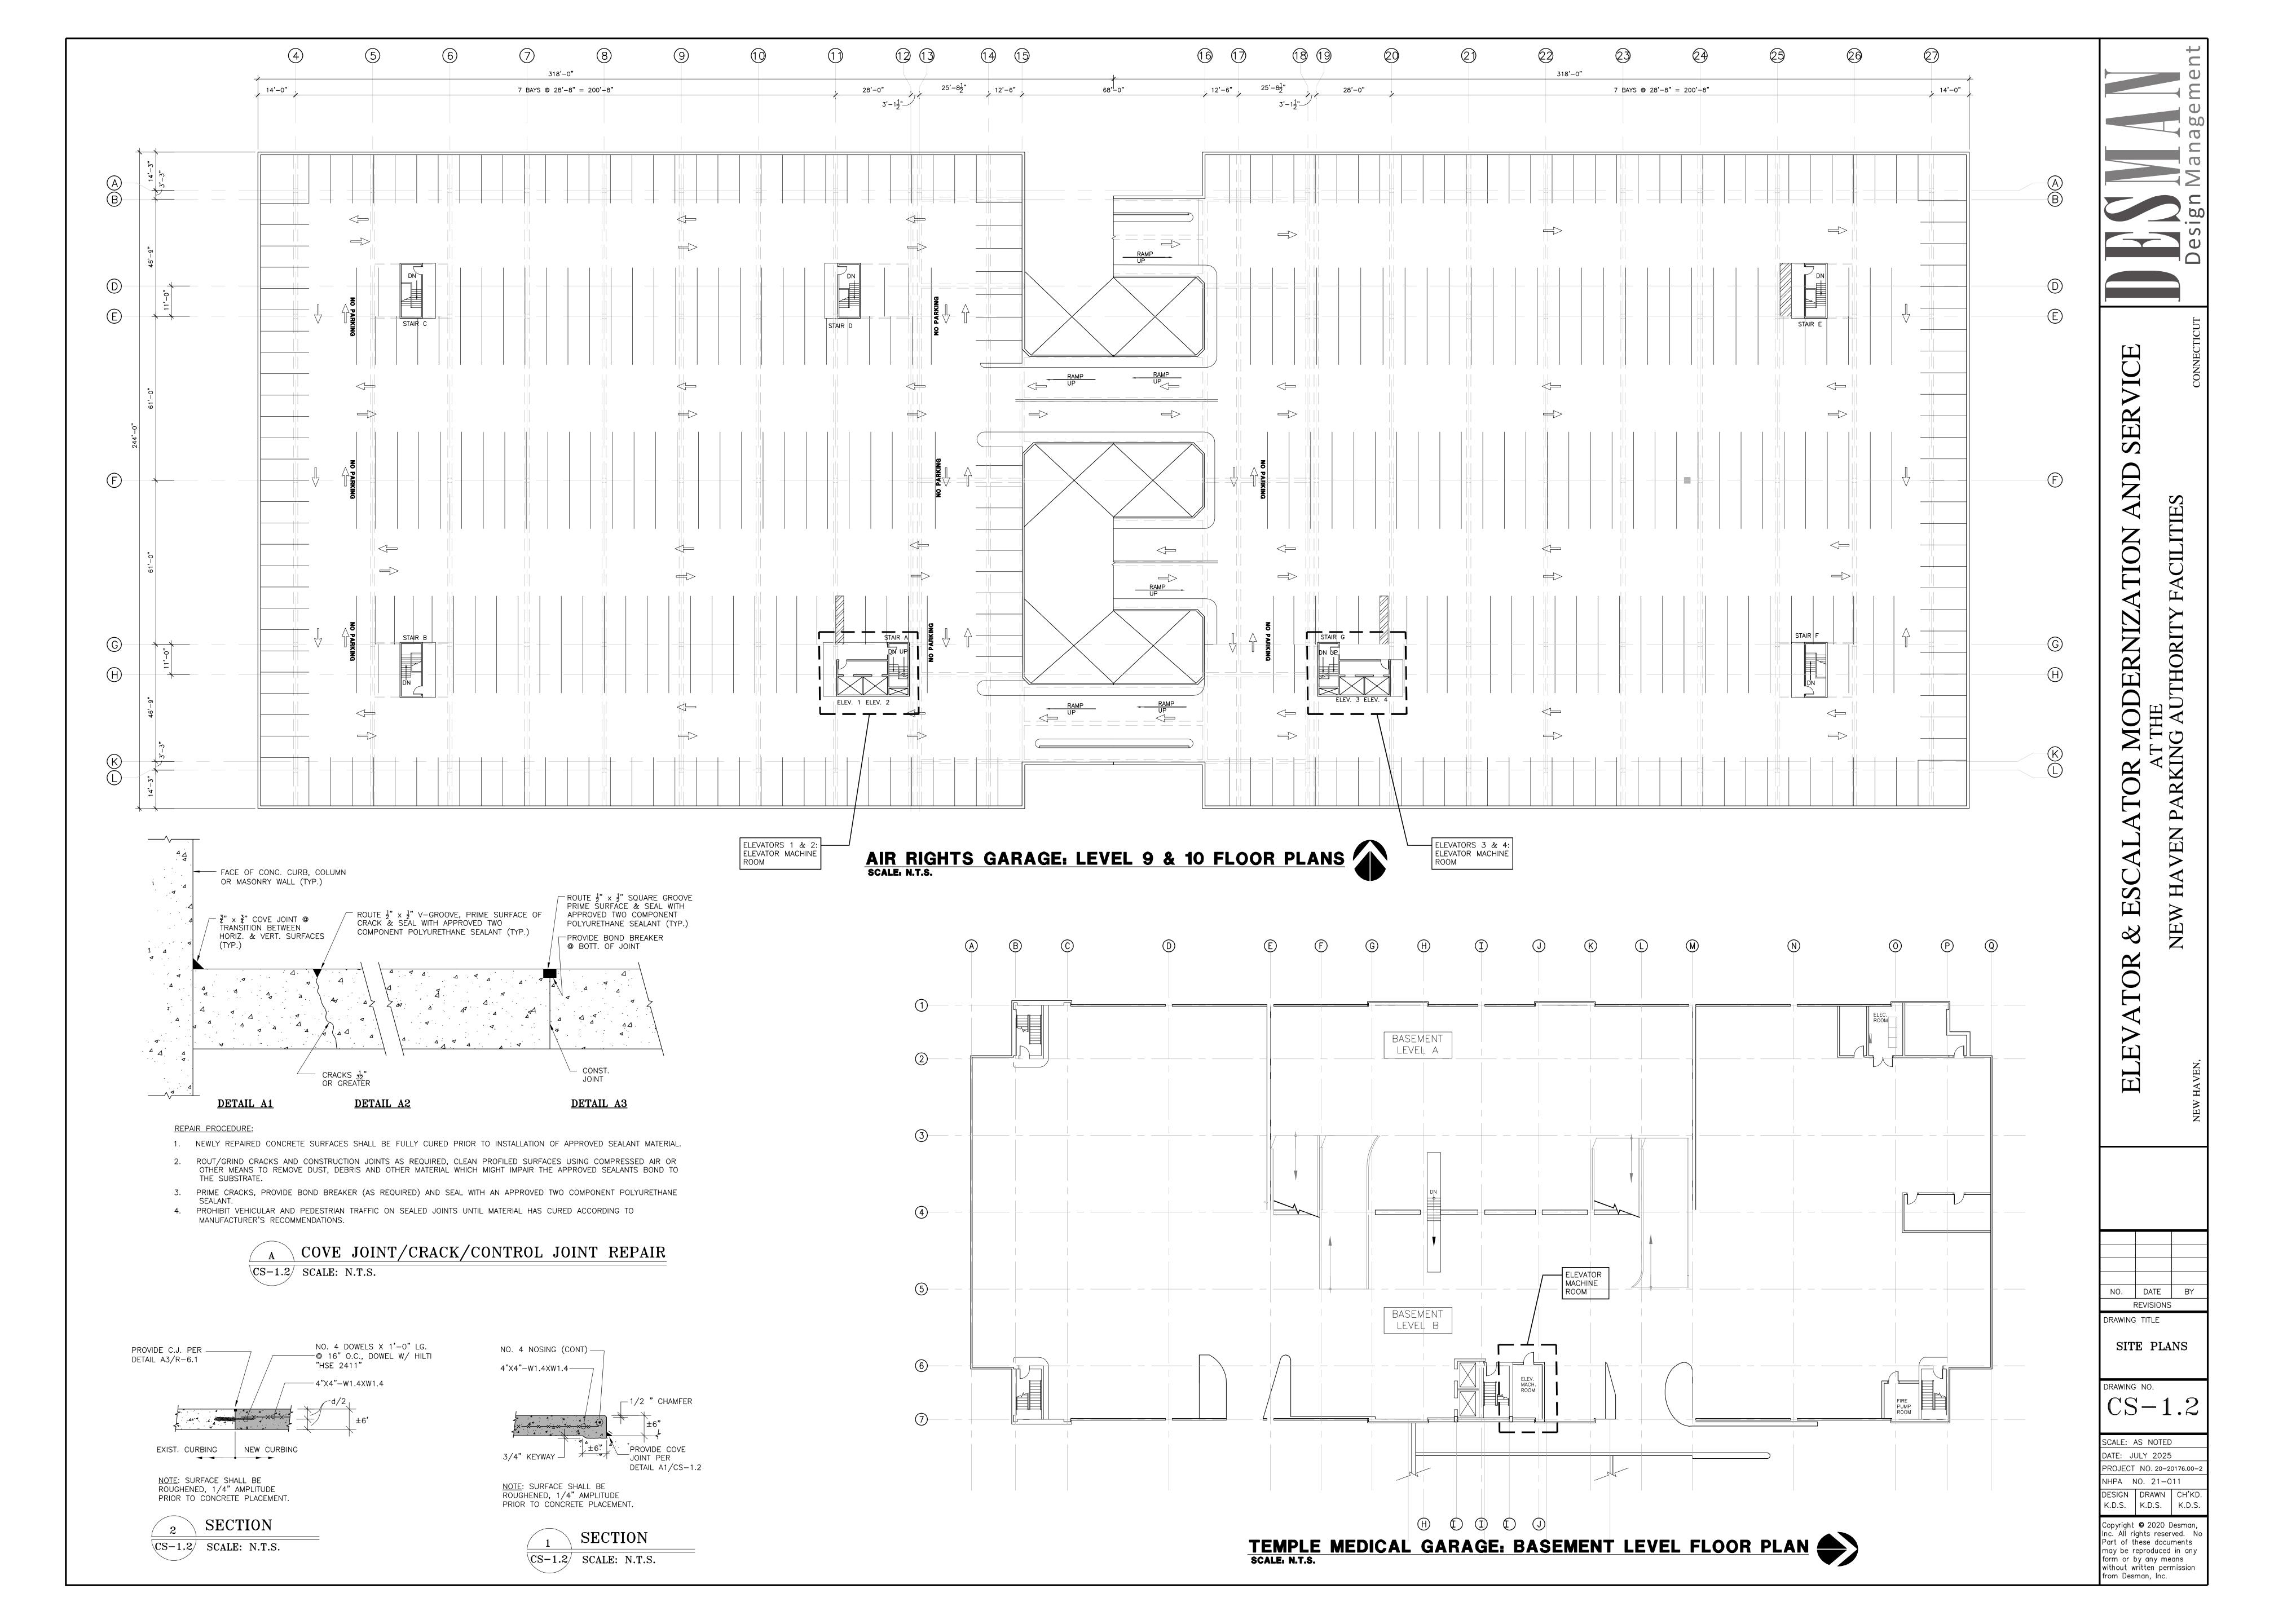
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SITE LOCATION PLAN






84 Orange Street + New Haven, Connecticut 203.786.5110 + www.svigals.com

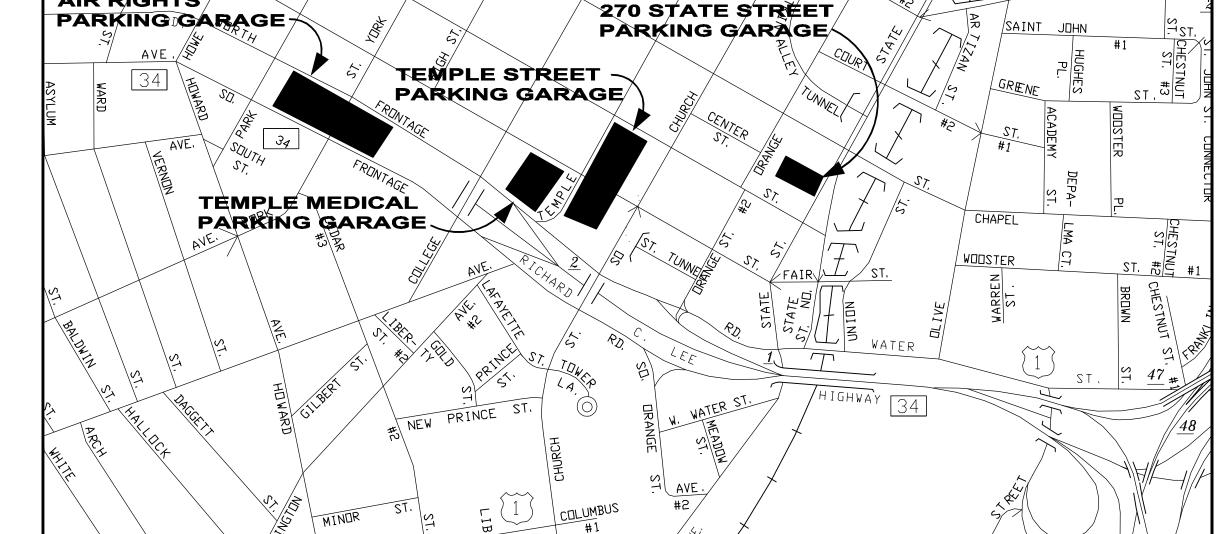ABBREVIATIONS

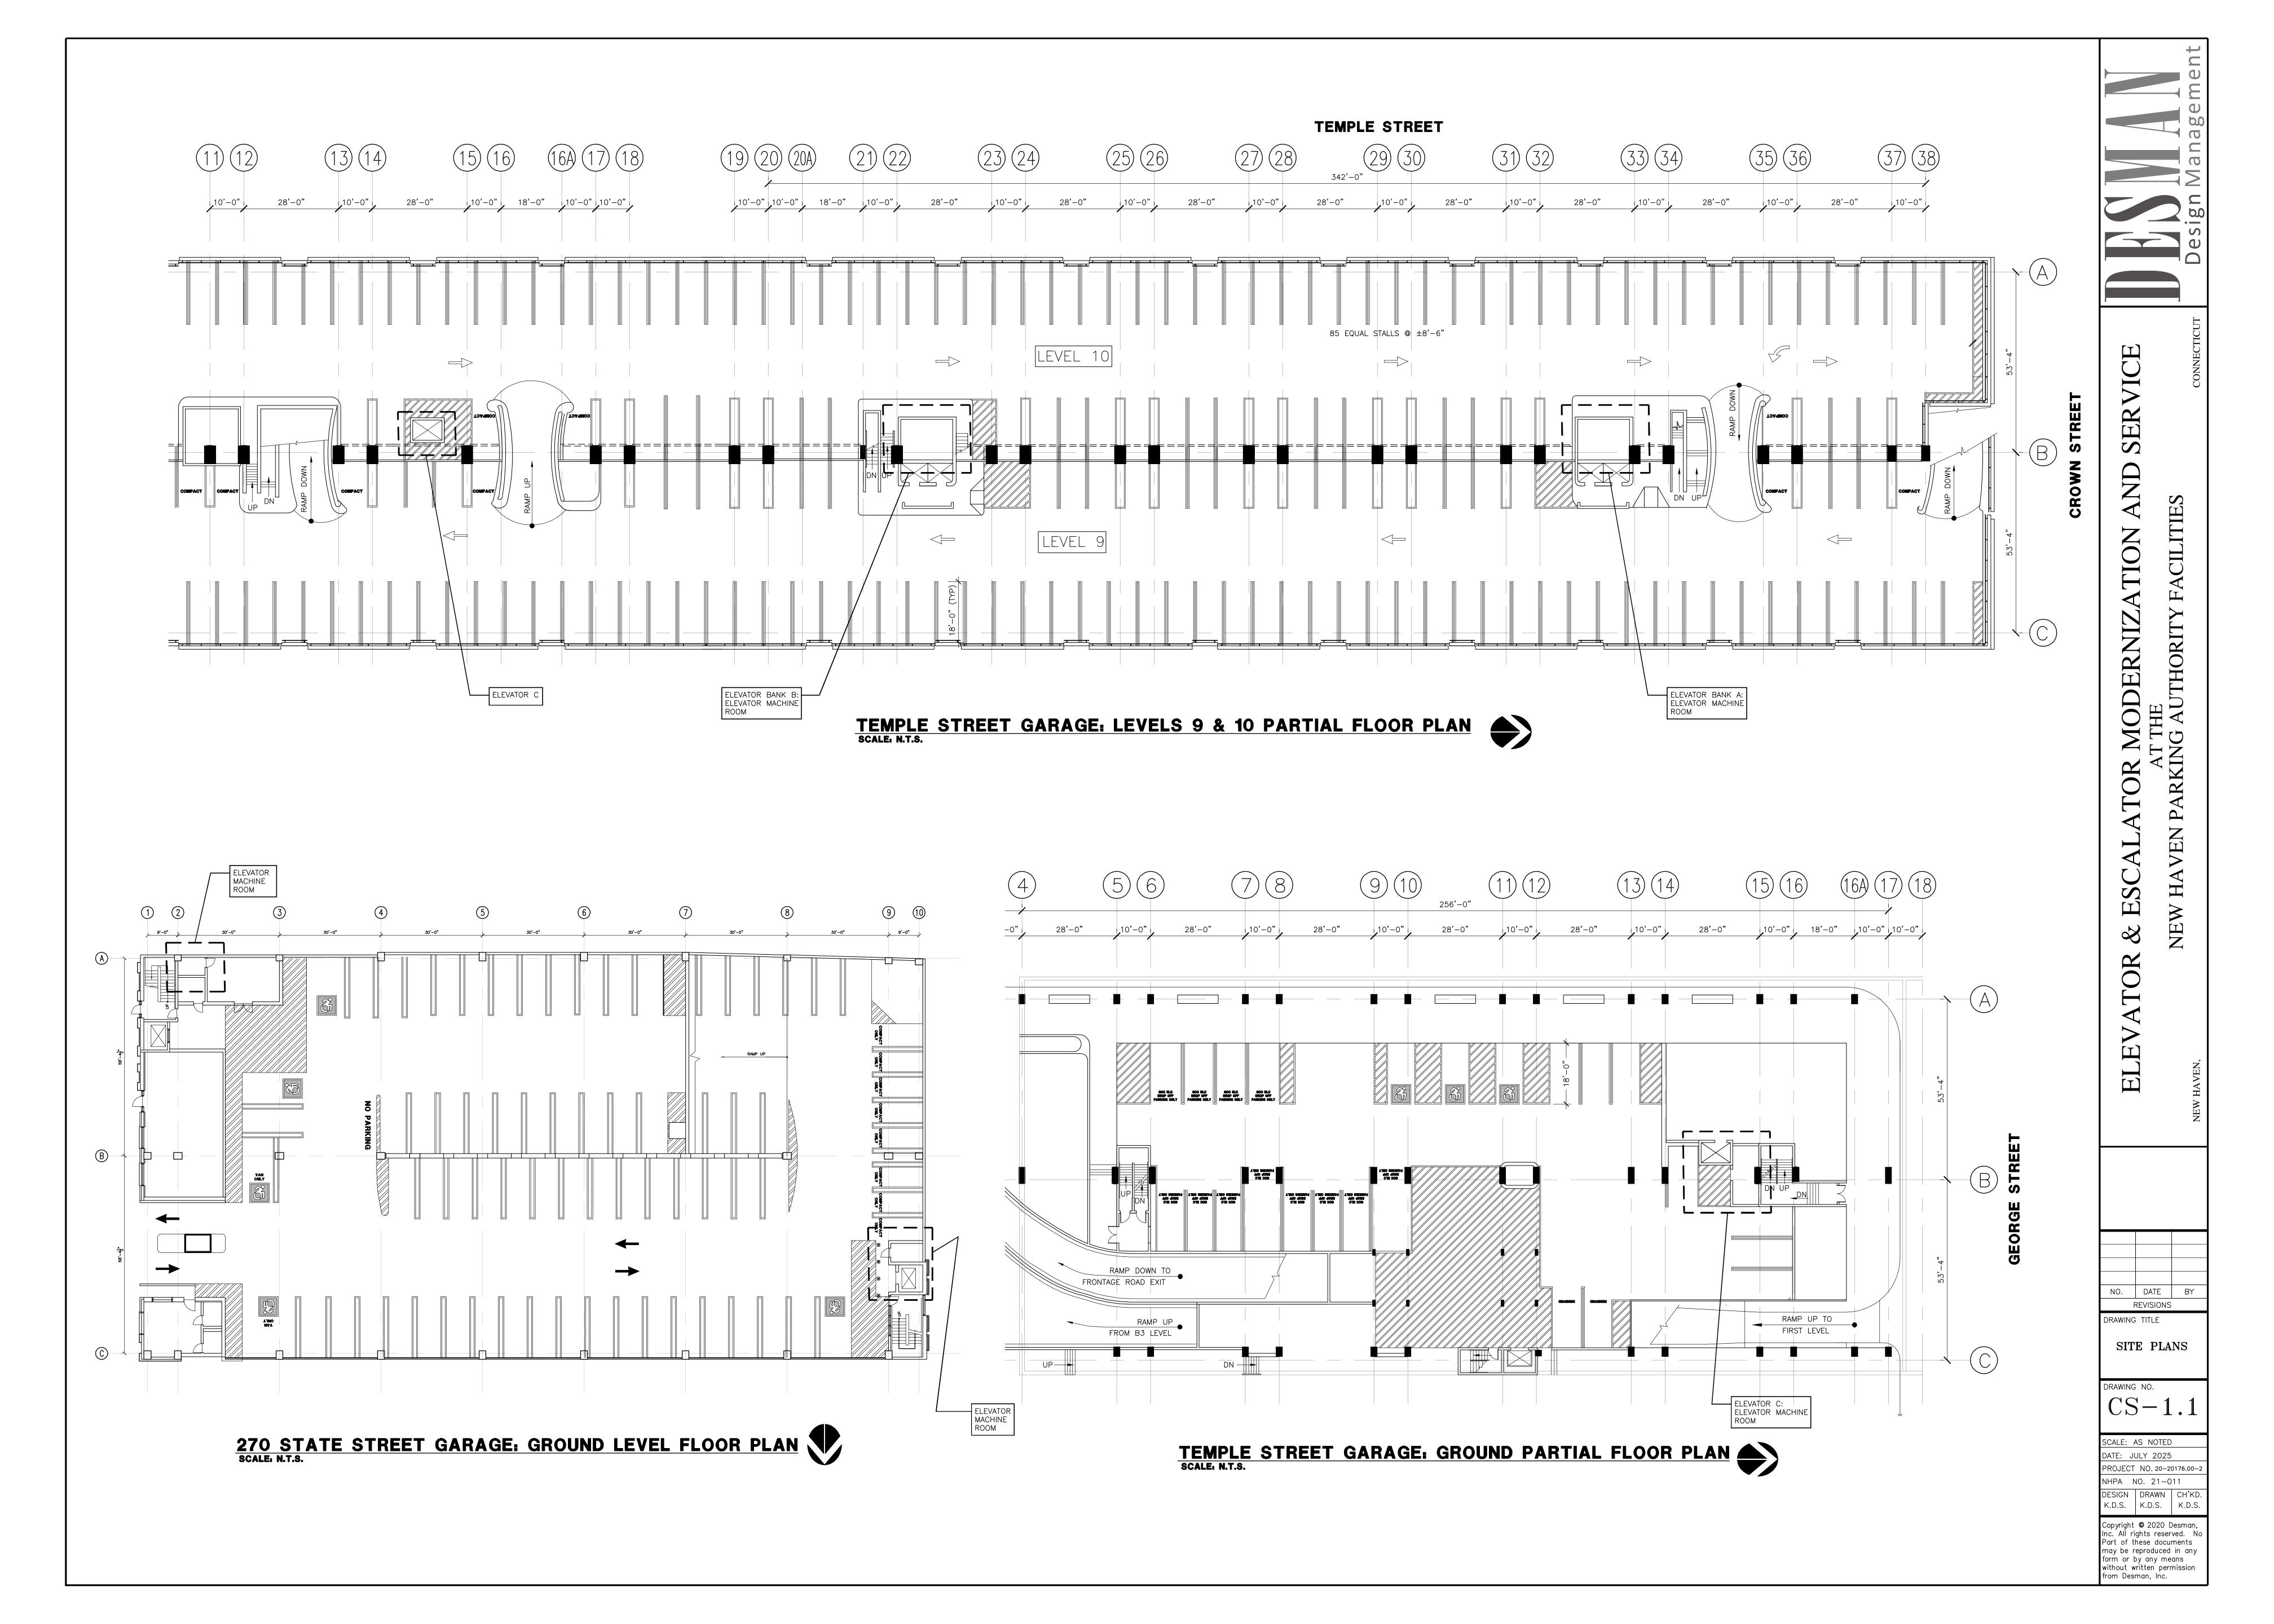@	AT	Е	EAST	LIMS	LIMESTONE	S	SOUTH
AB	ANCHOR BOLT	EA	EACH	LIN	LINEAR	SC	SOLIC CORE
ABV	ABOVE	EC	EXPOSED CONSTRUCTION	LTG	LIGHTING	SCHED	SCHEDULE
ACT	ACOUSTICAL CEILING TILE	EF	EXHAUST FAN	LTG. STND		SCS	SEALED CONCRETE SURFACE
ADJ	ADJACENT	ELEC	ELECTRICAL/ELECTRIC	LW	LIGHT WEIGHT	SD	STORM DRAIN
ADMIN	ADMINISTRATION	ELEV, EL	ELEVATION		METER	SEC	SECTION
AFF	ABOVE FINISHED FLOOR	EMERG	EMERGENCY	M	METER	SERV	SERVICE
AHU	AIR HANDLING UNIT	EQ, =	EQUAL	MAS	MASONRY	SF	SQUARE FOOT
ALT	ALTERNATE	EQUIP	EQUIPMENT	MATL	MATERIAL	SHTHG	SHEATHING
ALUM	ALUMINUM APPROXIMATE	EST EW	ESTIMATE(D)	MAX	MAXIMUM MARBLE	SIM	SIMILAR
APPROX		EWC	EXTERIOR WALL ELECTRIC WATER COOLER	MBL	MECHANICAL	SLDG	SLIDING
ARCH	ARCHITECT(URAL)	EXH	EXHAUST	MECH MFG,		SPEC	SPECIFICATION
BD.	BOARD	EXP		MANUF	MANUFACTURER	SPL	SPRINKLER
BD BF	BOTH FACES	EXT	EXPANSION EXTERIOR	MH	MANHOLE	SQ	SQUARE
BIT	BITUMINOUS		EXTERIOR	MIN	MINIMUM	SS, ST STL	STAINLESS STEEL
BLDG	BUILDING	FBRK	FACE BRICK	MISC	MISCELLANEOUS	SSM	SOLID SURFACE MATERIAL
BLK	BLOCK	FD	FLOOR DRAIN	MO	MASONRY OPENING	STD	STANDARD
BLKG	BLOCKING	FE FE	FIRE EXTINGUISHER	MTD	MOUNTED	STL	STEEL
BM	BEAM	FE CAB	FIRE EXTINGUISHER	MTL	METAL	STRUCT	STRUCTURAL
BOT	BOTTOM	FE CAB	CABINET	2		SUSP	SUSPENDED
BRK	BRICK	FF	FINISH FLOOR	N	NORTH	SYM	SYMMETRICAL
BS	BOTH SIDES	FIN	FINISH	NEG	NEGATIVE	SYS	SYSTEM
BSMT	BASEMENT	FIN GRD	FINISH GRADE	NIC	NOT IN CONTRACT	010	O TO TEIN
	BUILT-UP ROOFING	FIXT	FIXTURE	NO, #	NUMBER	т	THERMOSTAT
BUR	BUILT-UP ROOFING	FL	FLUSH	NOM	NOMINAL	T&B	TOP & BOTTOM
0.1	CHANNE	FLG	FLASHING	NTS	NOT TO SCALE	T&G	TONGUE & GROOVE
C, [CHANNEL CENTER	FLR	FLOOR	NIO	NOT TO SOALL	T/BLK	TOP OF BLOCK
C-C CAB	CENTER TO CENTER	FNDN	FOUNDATION	OA	OVERALL	T/CONC	TOP OF CONCRETE
	CATCLERASIN	FP	FIREPROOF	OC, O/C	ON CENTER	T/CURB	TOP OF CURB
CB	CATCH BASIN	FPL	FIREPLACE	OD	OUTSIDE DIAMETER	T/DECK,	TOP OF DECK
CEM	CEMENT	FT	FOOT (FEET)	OH	OVERHEAD	TOD	TOT OF BEOK
CF	CURTAIN FABRIC	FTG	FOOTING	OH, OPH	OPPOSITE HAND	T/FTG	TOP OF FOOTING
CFL	COUNTER FLASHING	FUT	FUTURE	OPG	OPENING	T/SLAB	TOP OF SLAB
CFT	CERAMIC FLOOR TILE	101	TOTORE	OPP	OPPOSITE	T/STL	TOP OF STEEL
CI	CAST IRON	GA	GAUGE	OFF	OFFOSITE	T/WALL	TOP OF WALL
CJT	CONSTRUCTION JOINT	GALV	GALVANIZED	PC	PRECAST	ТВ	TACKBOARD
CL	CENTERLINE CEILING	GFB	GROUND FACE BLOCK	PERF	PERFORATE(D)	TBD	TO BE DETERMINED
CLG		GL	GLASS, GLAZING	PF	PANEL FABRIC	TD	TRENCH DRAIN
CLK CLL	CAULK CONTRACT LIMIT LINE	GRD	GRADE	PL	PLATE	TEL	TELEPHONE
CLOS	CLOSET		GYPSUM DRY WALL	PL	PROPERTY LINE	TEMP	TEMPERATURE
	CLEAR	OVID, OTT.	OTT COM BICT WALL	PLAM, PL	PLASTIC LAMINATE	THK	THICK
CLR CLRM	CLASSROOM	Н	HIGH	PLAS	PLASTER	THRES	THRESHOLD
CLRIVI	CONCRETE MASONRY UNIT	HC	HANDICAP(PED)	PNL	PANEL	TR	TREAD
CNJT	CONTROL JOINT	HD	HAND	PNT	POINT	TYP	TYPICAL
CO	CONVENIENCE OUTLET	HDRM	HEADROOM	POL	POLISHED	TZ	TERRAZZO
COL	COLUMN	HDW	HARDWARE	POS	POSITIVE	TZB	TERRAZZO BASE
COMB	COMBINATION	HGT	HEIGHT	PROJ	PROJEC(TION)	TZT	TERRAZZO TILE
CONC	CONCRETE	HM	HOLLOW METAL	PSF	POUNDS PER SQ FT		
CONST	CONSTRUCTION	HOR	HORIZONTAL	PSI	POUNDS PER SQ INCH	UL	UNDERWRITERS
CONT	CONTINUOUS	HTG	HEATING	PT	PAINT		LABORATORIES
CORR	CORRIDOR	HVAC	HEATING/VENTILATION/AIR	PTD	PAINTED	UNFIN	UNIFINISHED
CP	CLAY PIPE		CONDITIONING	PTN	PARTITION	UNO	UNLESS NOTED OTHERWISE
CPG	COPING			PVMT	PAVEMENT	UOD	UNDERSIDE OF DECK
CPT	CARPET	ID	INSIDE DIAMETER	PVR	PAVER		
CRS, C	COURSE	IN	INCH	PWD,	PLYWOOD	VB	VAPOR BARRIER
CT CT	CERAMIC TILE	INSUL	INSULATION	PLYWD		VCT	VINYL COMPOSITE TILE
СТВ	CERAMIC TILE BASE	INT	INTERIOR			VERT	VERTICAL
CTR	CENTER	INTERM	INTERMEDIATE	QT	QUARRY TILE	VET	VINYL ENHANCED TILE
CTSK	COUNTERSINK	INV	INVERT	QUTB	QUARRY TILE BASE	VNR	VENEER
CUH	CABINET UNIT HEATER					VTR	VENT THROUGH ROOF
CWT	CERAMIC WALL TILE	JC	JANITOR CLOSET	R	RISER	VWC	VINYL WALL COVERING
		JNT/JT	JOINT	RAD, R	RADIUS		
DBL	DOUBLE			RADN	RADIATOR, RADIATION	W	WEST
DIA	DIAMETER	KD	KNOCK DOWN	RB	RUBBER BASE	W/	WITH
DIAG	DIAGONAL	KO	KNOCK OUT	RD	ROOF DRAIN	W/O	WITHOUT
DIFF	DIFFUSER	KS	KNEE SPACE	REQD	REQUIRED	WB	WOOD BASE
DIM, DIMS	DIMENSION(S)			REV	REVERSE	WD	WOOD
DN DIVIO	DOWN	L	ANGLE	RF	RUBBER FLOORING	WF	WALL FABRIC
DO	DITTO	L	LENGTH	RFG	ROOFING	WI	WIDTH
DP	DAMPROOFING	LAM	LAMINATE	RH	RIGHT HAND	WIN	WINDOW
DR	DOOR	LAV	LAVATORY	RH	REVERSE HAND	WP	WATERPROOFING
DRN	DRAIN	LB	POUND	RM	ROOM	WSCT	WAINSCOT
DTL	DETAIL	LBL	LABEL	RO	ROUGH OPENING	WT, WGT	WEIGHT
∟	DRAWING	LH	LEFT HAND	ROW	RIGHT OF WAY	WTR	WATER
DWG	DRAWING						
DWG	DRAWING			RS	ROLLER SHADE	WWF	WELDED WIRE FABRIC

GRAPHIC LEGEND

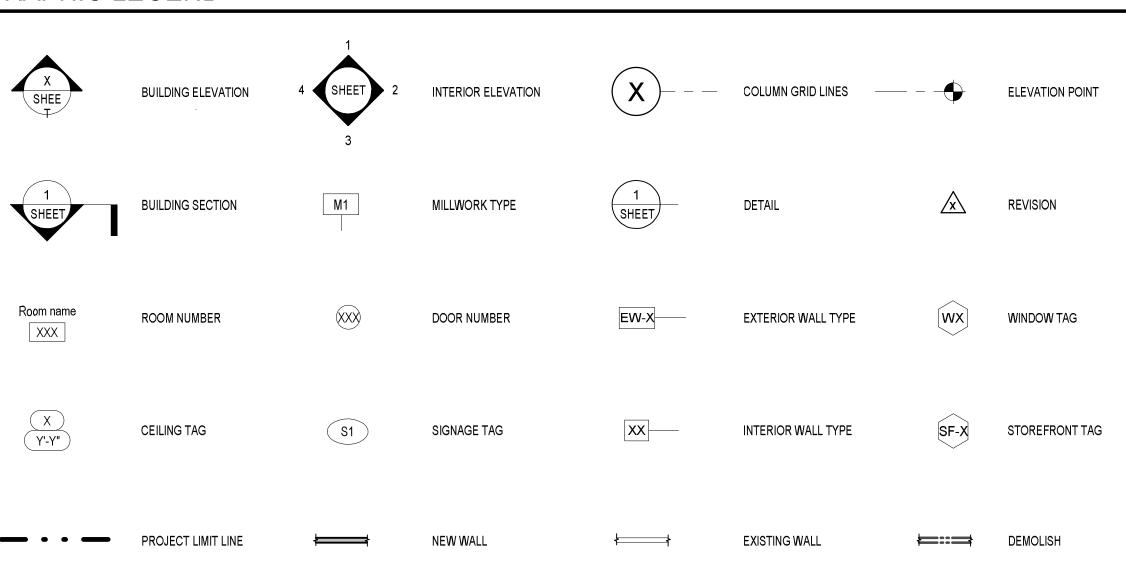







					FINI	SH LEGEND	
ITEM	NAME	SIZE	MANUFACTURER	STYLE	COLOR	LOCATION	NOTES
EPX-1	EPOXY FLOOR	MACROCHIP	DURAFLEX	HYBRI-FLEX SERIES EC	TBD	REFER TO 1ST FLOOR PLAN	PREP PRIOR TO APPLICATION, REFER TO MANUFACTURES RECOMMENDATIONS
EPX-2	EPOXY FLOOR	MACROCHIP	DURAFLEX	HYBRI-FLEX SERIES EC	TBD	REFER TO 2ND FLOOR PLAN	PREP PRIOR TO APPLICATION, REFER TO MANUFACTURES RECOMMENDATIONS
EPX-3	EPOXY FLOOR	MACROCHIP	DURAFLEX	HYBRI-FLEX SERIES EC	TBD	REFER TO 3RD FLOOR PLAN	PREP PRIOR TO APPLICATION, REFER TO MANUFACTURES RECOMMENDATIONS
EPX-4	EPOXY FLOOR	MACROCHIP	DURAFLEX	HYBRI-FLEX SERIES EC	TBD	REFER TO 4TH FLOOR PLAN	PREP PRIOR TO APPLICATION, REFER TO MANUFACTURES RECOMMENDATIONS
PT-1	PAINT		SHERWIN WILLIAMS	FLAT	BRIGHT WHITE	EXISTING CONCRETE DECK & BEAMS, REF PLANS	LOXON XP WATERPROOFING SYSTEM, PREP PRIOR TO APPLICATION, REFER TO MANUFACTURES RECOMMENDATIONS
PT-2	PAINT		SHERWIN WILLIAMS	EGGSHELL	BRIGHT WHITE	EXISTING HANDRAILS	PREP PRIOR TO APPLICATION, REFER TO MANUFACTURES RECOMMENDATIONS
PT-3	PAINT		SHERWIN WILLIAMS	EGGSHELL	TBD	REFER TO 1ST FLOOR PLAN & SIGNAGE	EXTERIOR GRADE
PT-4	PAINT		SHERWIN WILLIAMS	EGGSHELL	TBD	REFER TO 2ND FLOOR PLAN & SIGNAGE	EXTERIOR GRADE
PT-5	PAINT		SHERWIN WILLIAMS	EGGSHELL	TBD	REFER TO 3RD FLOOR PLAN & SIGNAGE	EXTERIOR GRADE
PT-6	PAINT		SHERWIN WILLIAMS	EGGSHELL	TBD	REFER TO 4TH FLOOR PLAN & SIGNAGE	EXTERIOR GRADE

SERVICE

ATION AND ELEVATOR

DRAWING LIST, NOTES, ABBREVIATIONS, & FINISH LEGEND


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CE Design Management

ELEVATOR & ESCALATOR MODERNIZATION AND SERVICE
AT THE
NEW HAVEN PARKING ALITHORITY FACILITIES

NO. DATE BY

REVISIONS

TITLE

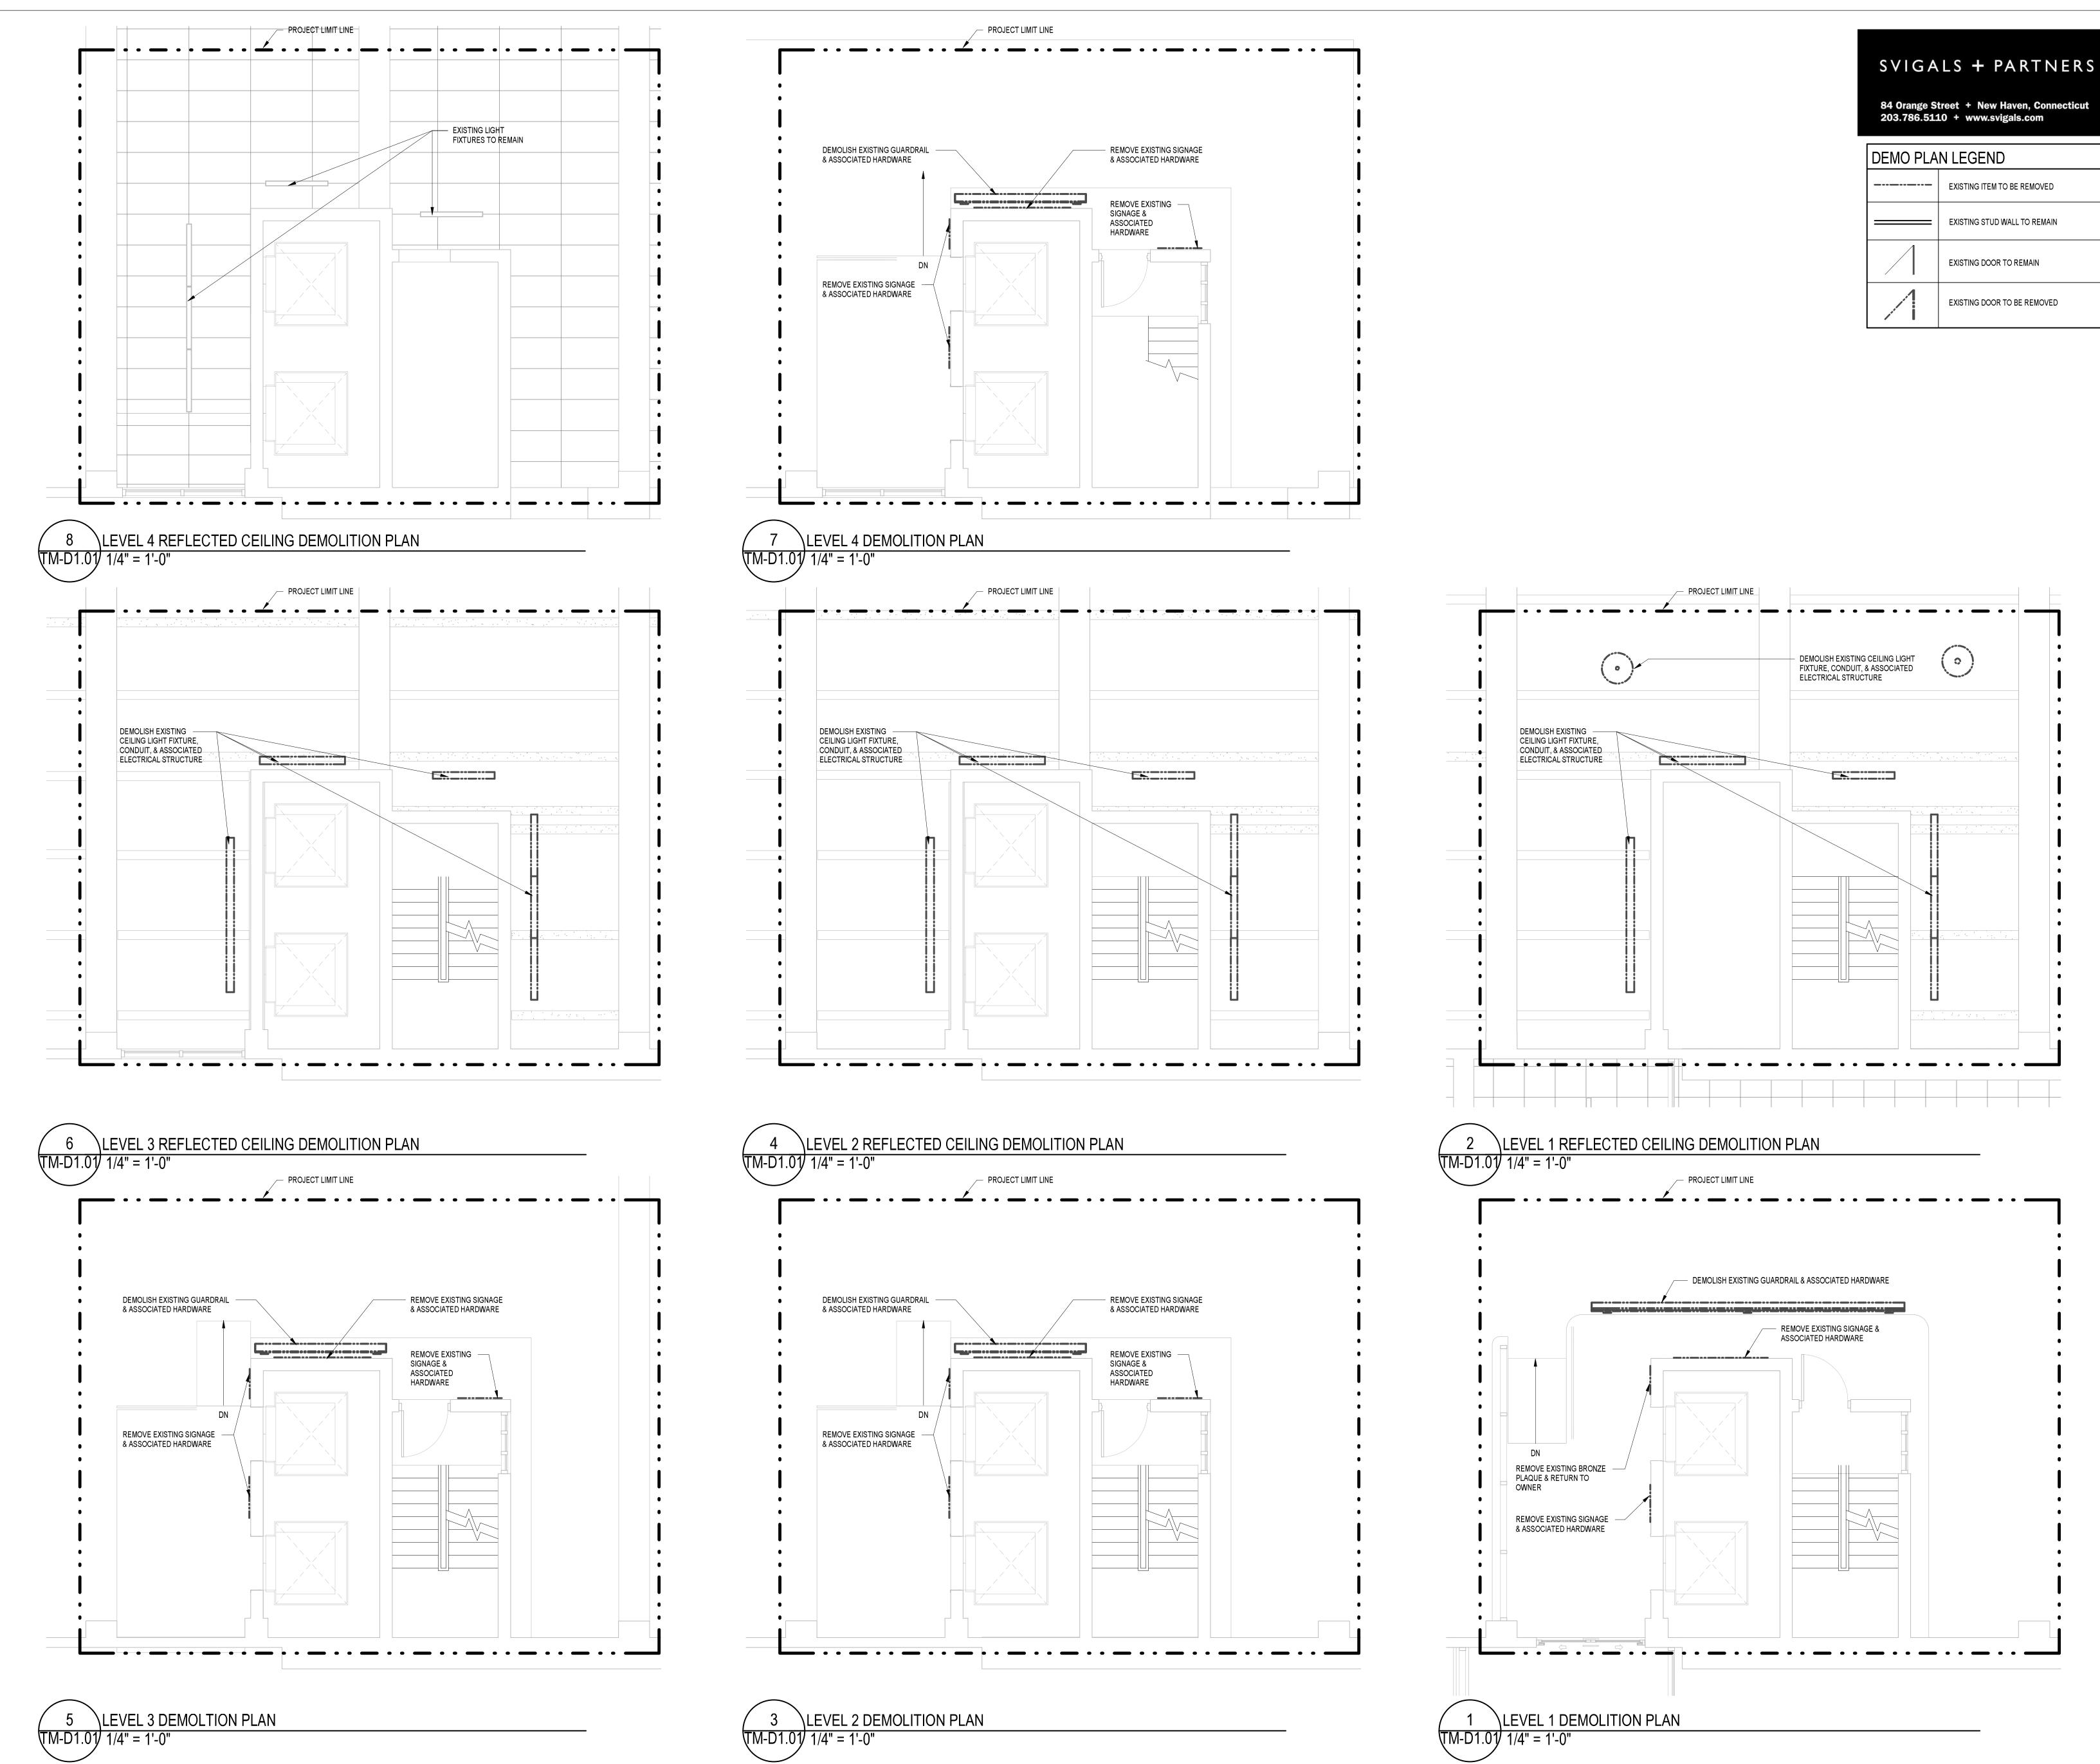DEMOLITION FLOOR


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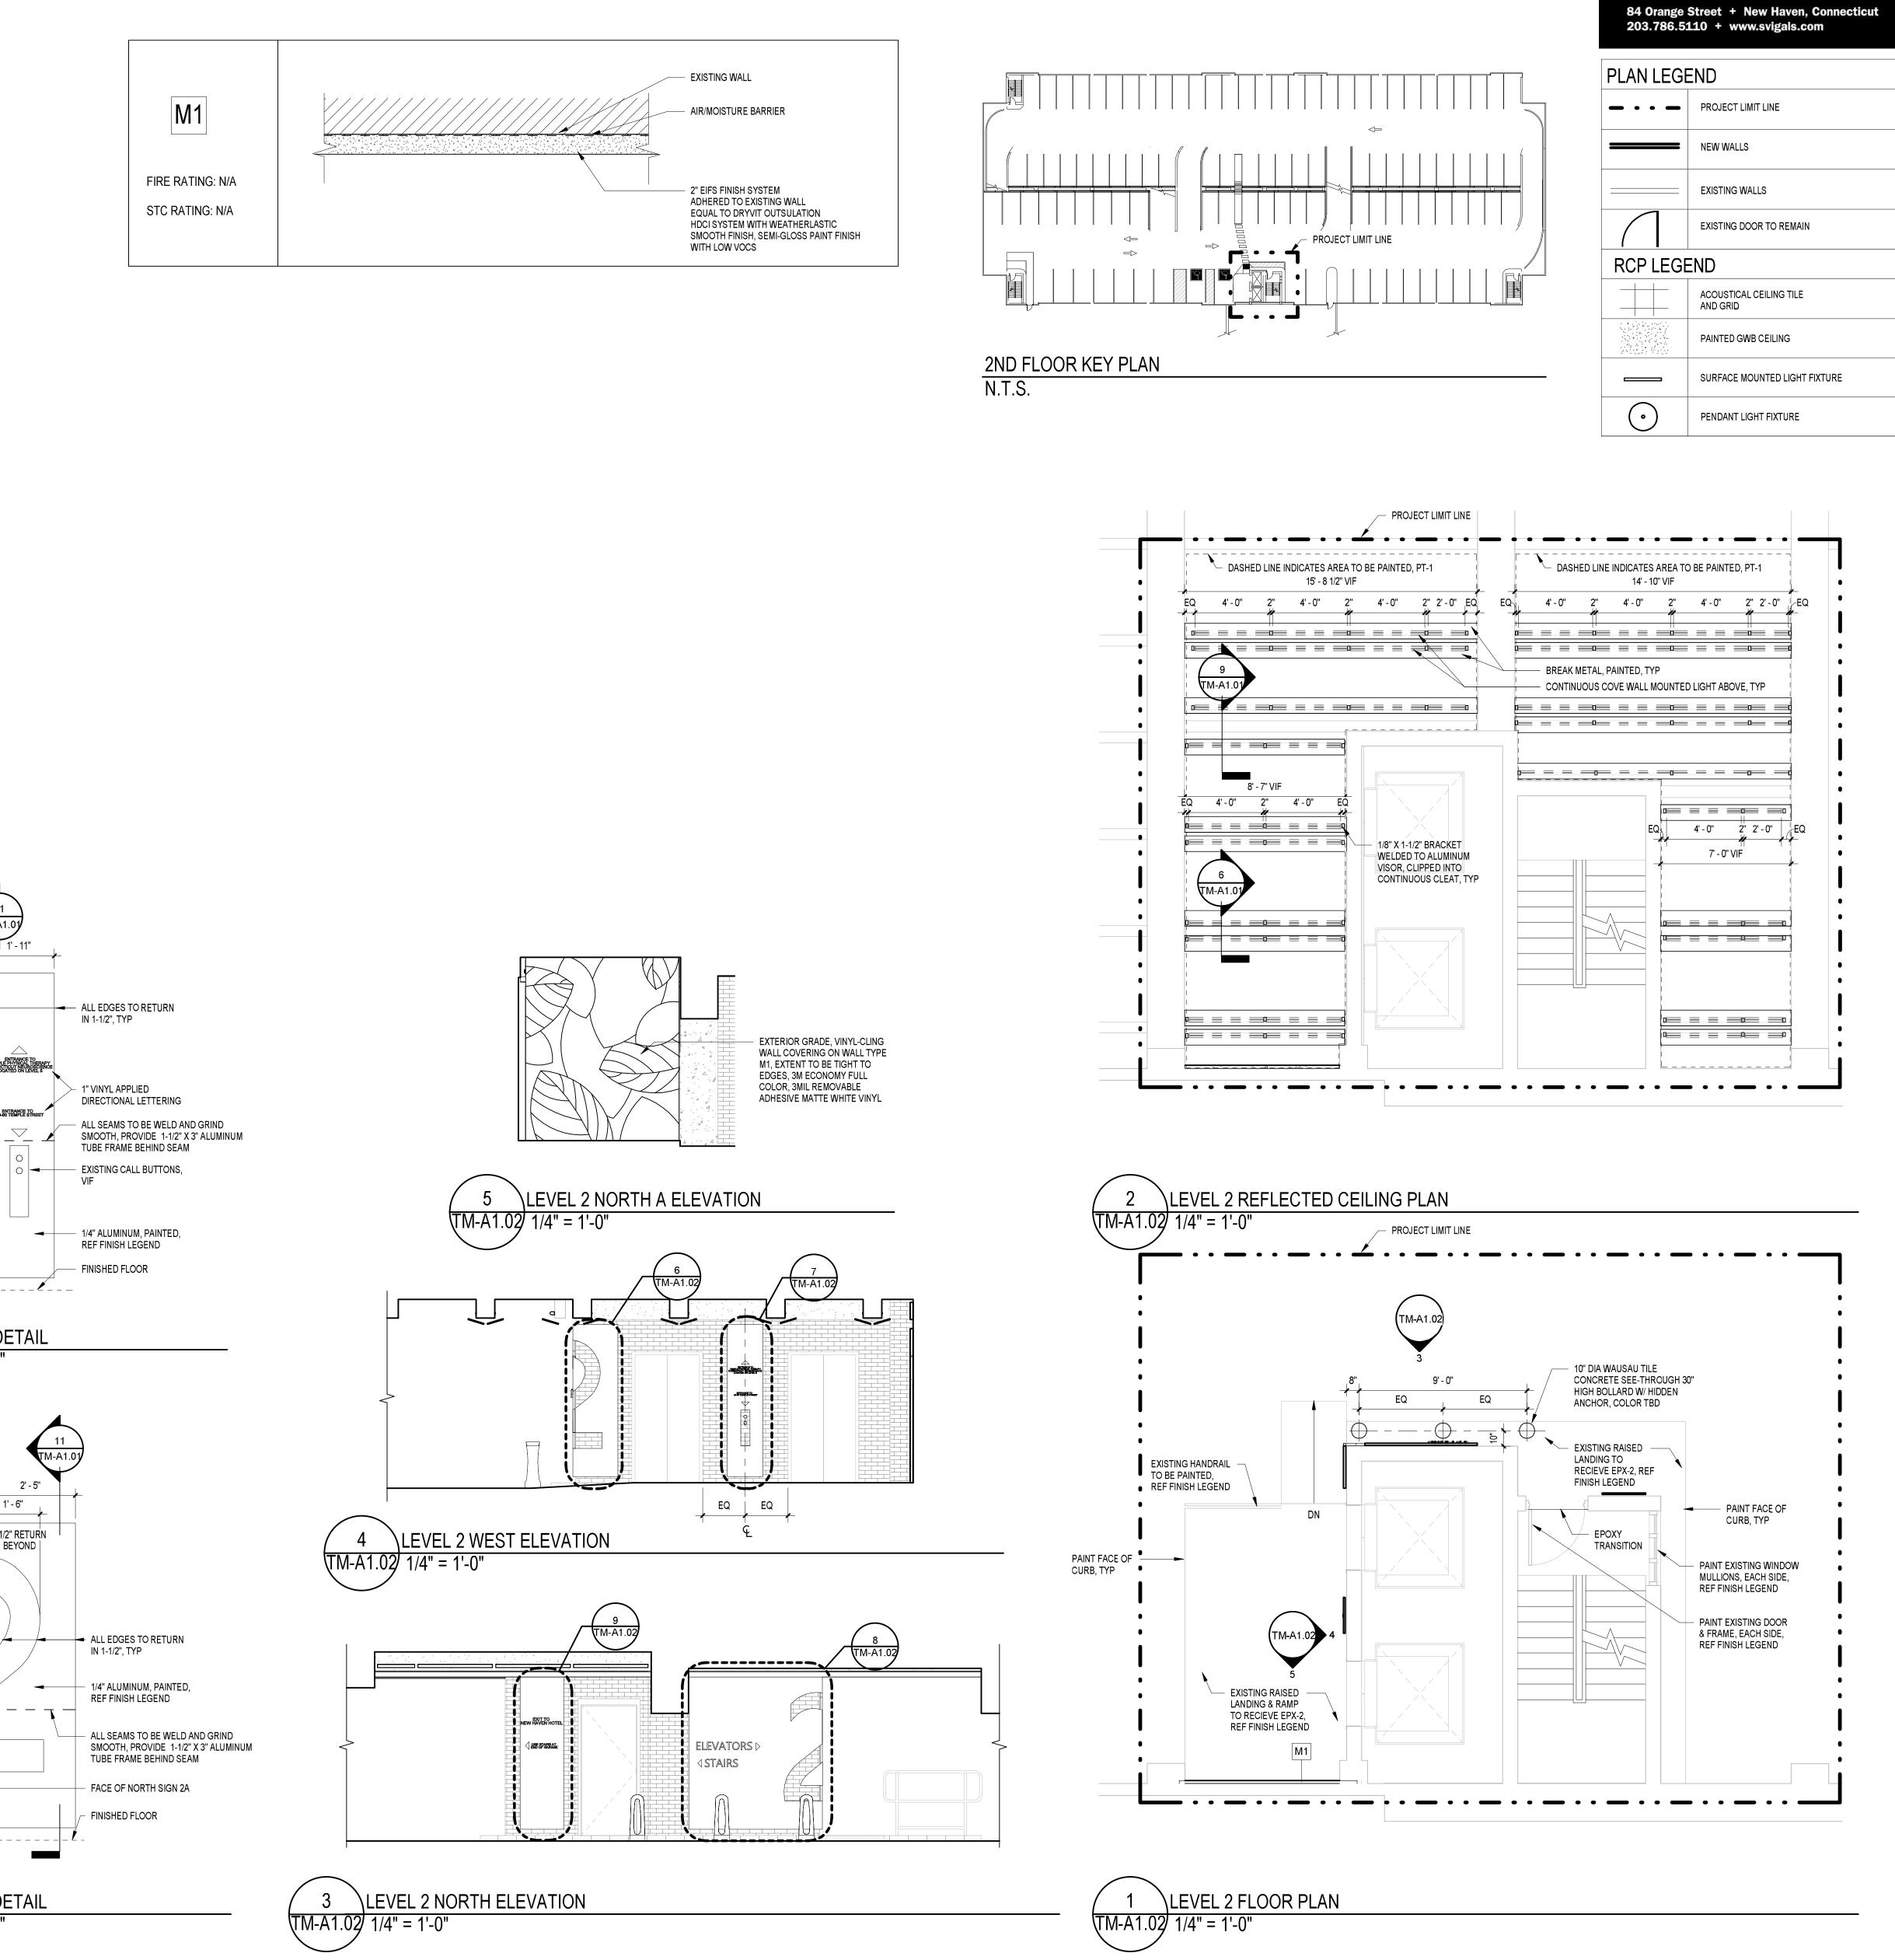
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SCALE: NOTED
DATE: JULY 2025
NO. 21-011
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ALL EDGES TO RETURN

DIRECTIONAL LETTERING

DIRECTIONAL LETTERING

- ALL SEAMS TO BE WELD AND GRIND

TUBE FRAME BEHIND SEAM

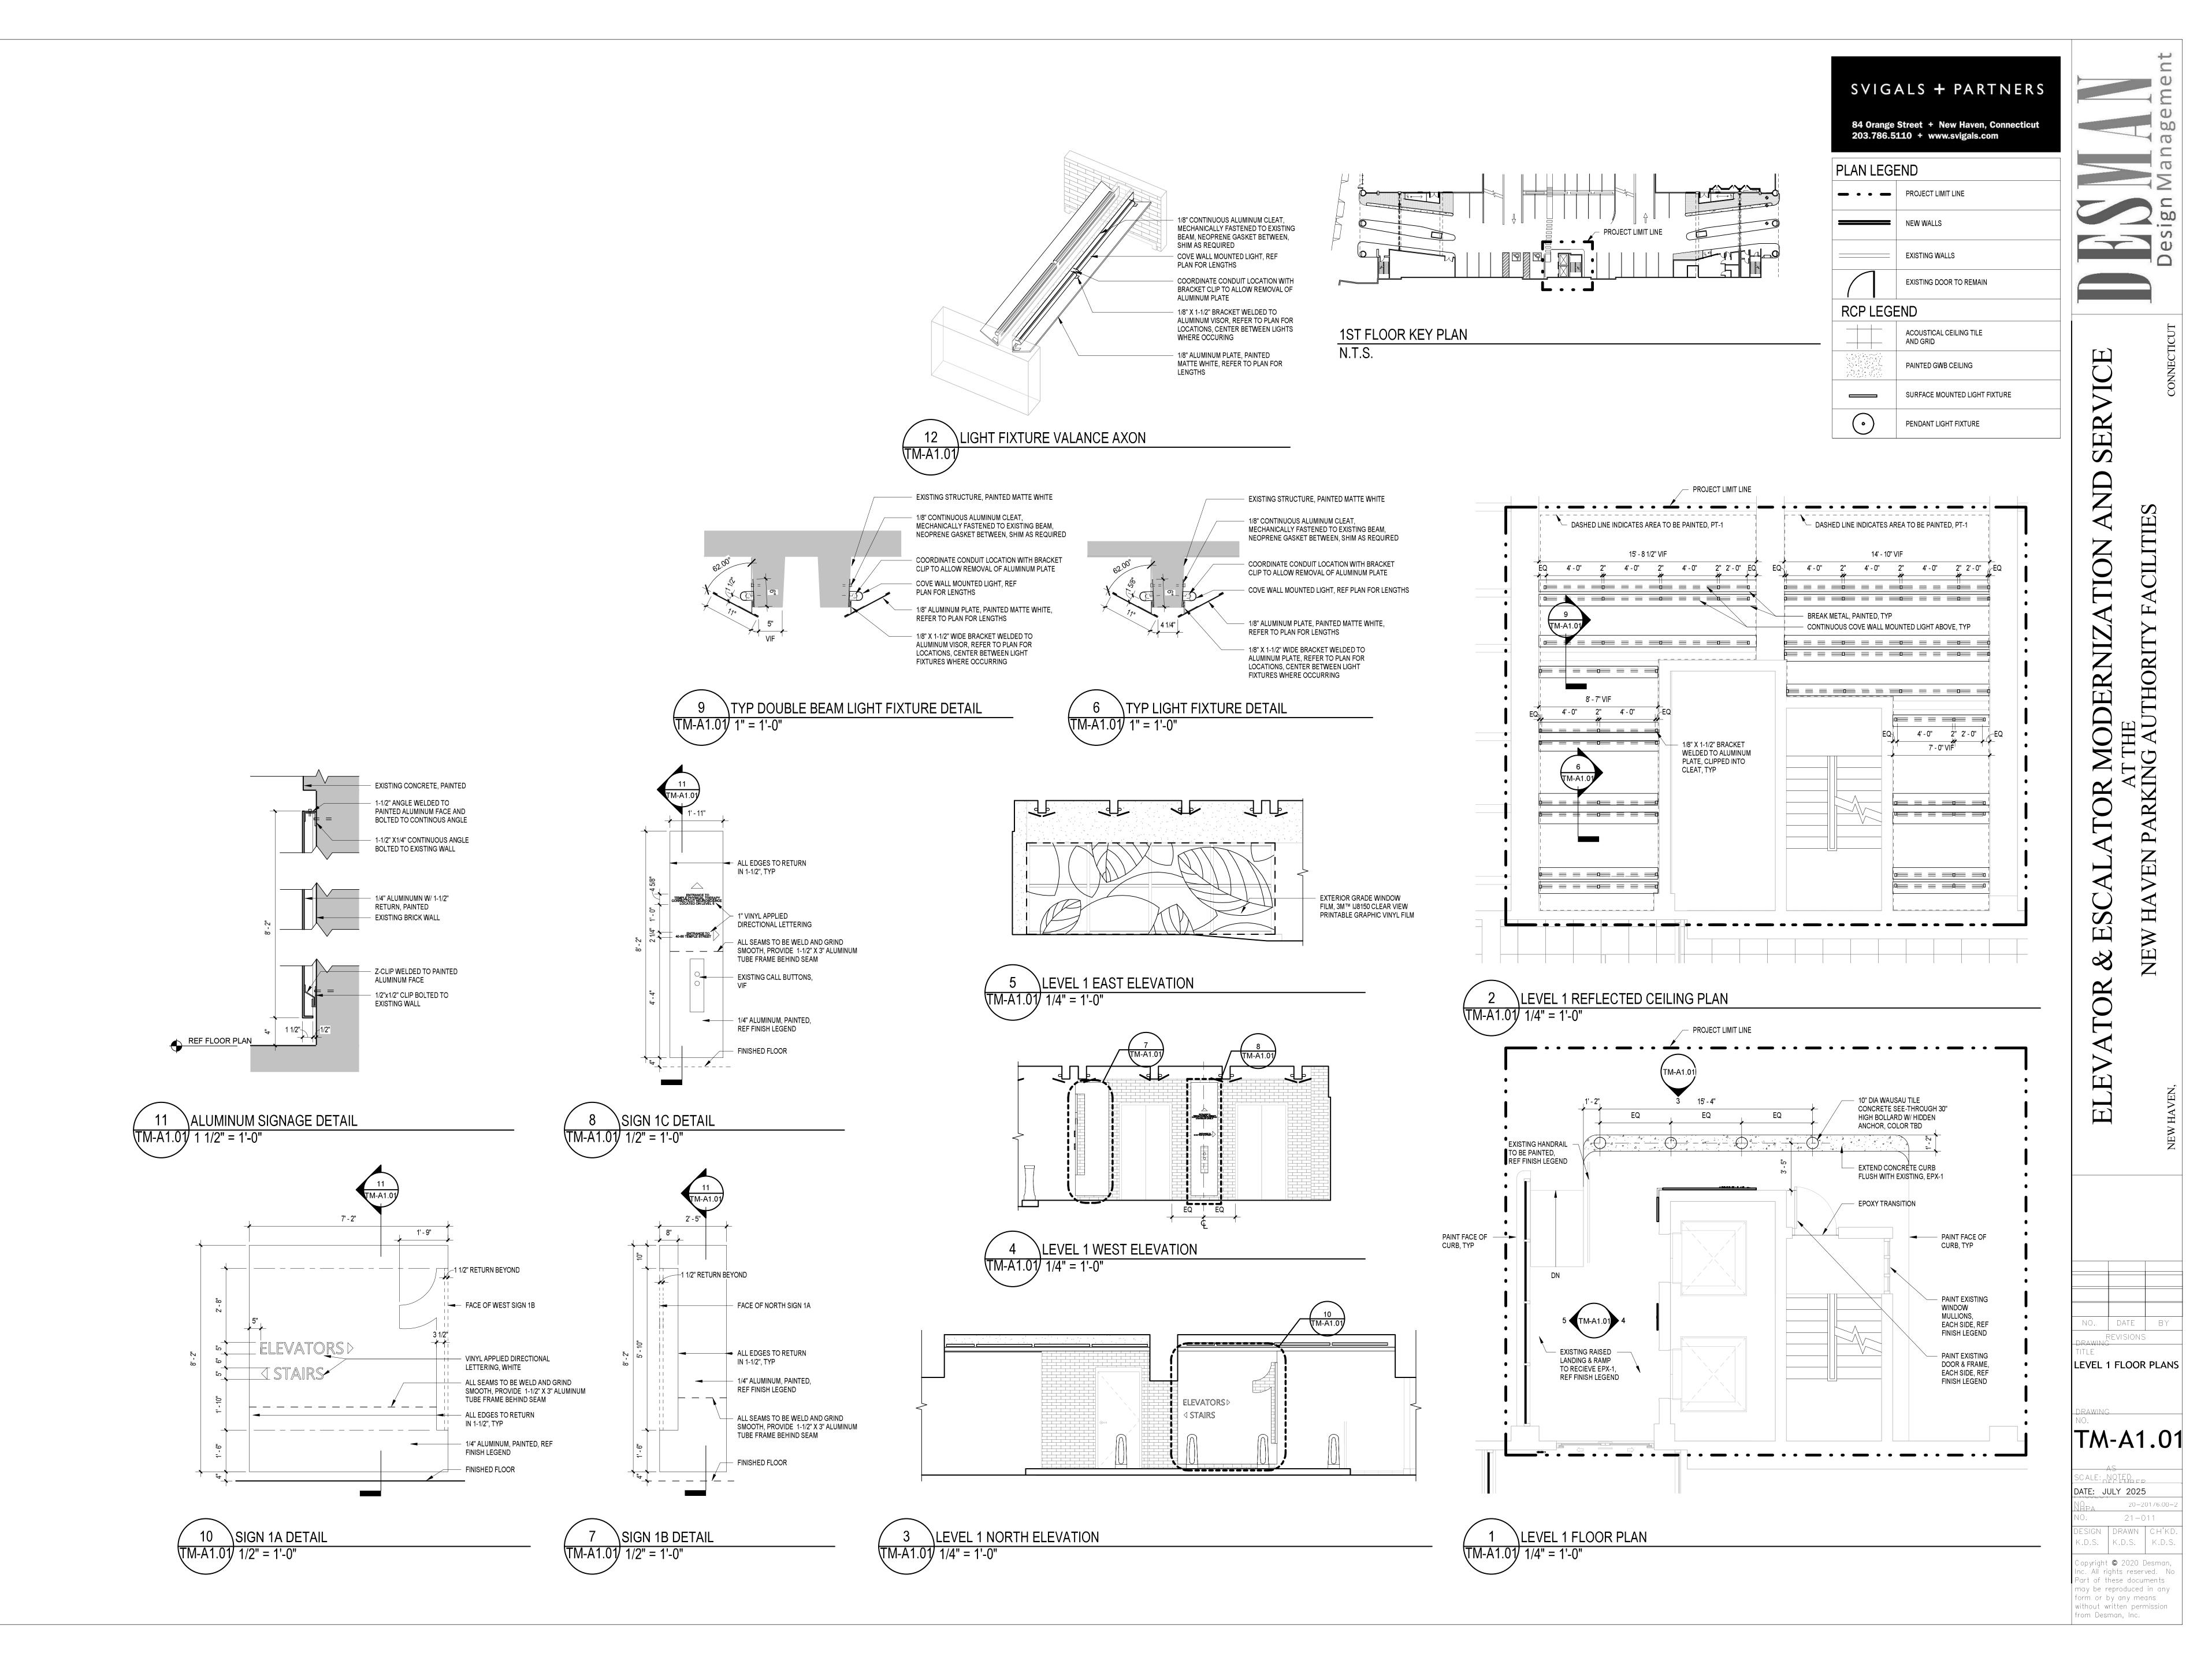REF FINISH LEGEND

1' - 8"

1 1/2" RETURN BEYOND

→ FACE OF WEST SIGN 2B

DIRECTIONAL LETTERING,

TUBE FRAME BEHIND SEAM

ALL SEAMS TO BE WELD AND GRIND

SMOOTH, PROVIDE 1-1/2" X 3" ALUMINUM

- VINYL APPLIED

WHITE

ALL EDGES TO RETURN

1/4" ALUMINUM, PAINTED,

REF FINISH LEGEND

- FINISHED FLOOR

/_____ IN 1-1/2", TYP

FINISHED FLOOR

→ 1/4" ALUMINUM, PAINTED,

SMOOTH, PROVIDE 1-1/2" X 3" ALUMINUM

SIGN 2C DETAIL

1' - 6"

BEYOND |

SIGN 2B DETAIL

TM-A1.02 1/2" = 1'-0"

1 1/2" RETURN

TM-A1.02 1/2" = 1'-0"

IN 1-1/2", TYP

NEW HAVEN HOTEL 2" VINYL APPLIED

7' - 2"

\SIGN 2D DETAIL

4

SIGN 2A DETAIL

TM-A1.02 1/2" = 1'-0"

USE STAIRS AT 1-1/2" VINYL APPLIED

ICE

SVIGALS + PARTNERS

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NO. DATE BY


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REVISIONS LEVEL 2 FLOOR PLANS

TM-A1.02

SCALE: NOTED DATE: JULY 2025 20-201/6.00-2 0. 21-011 DESIGN DRAWN CH'KD.

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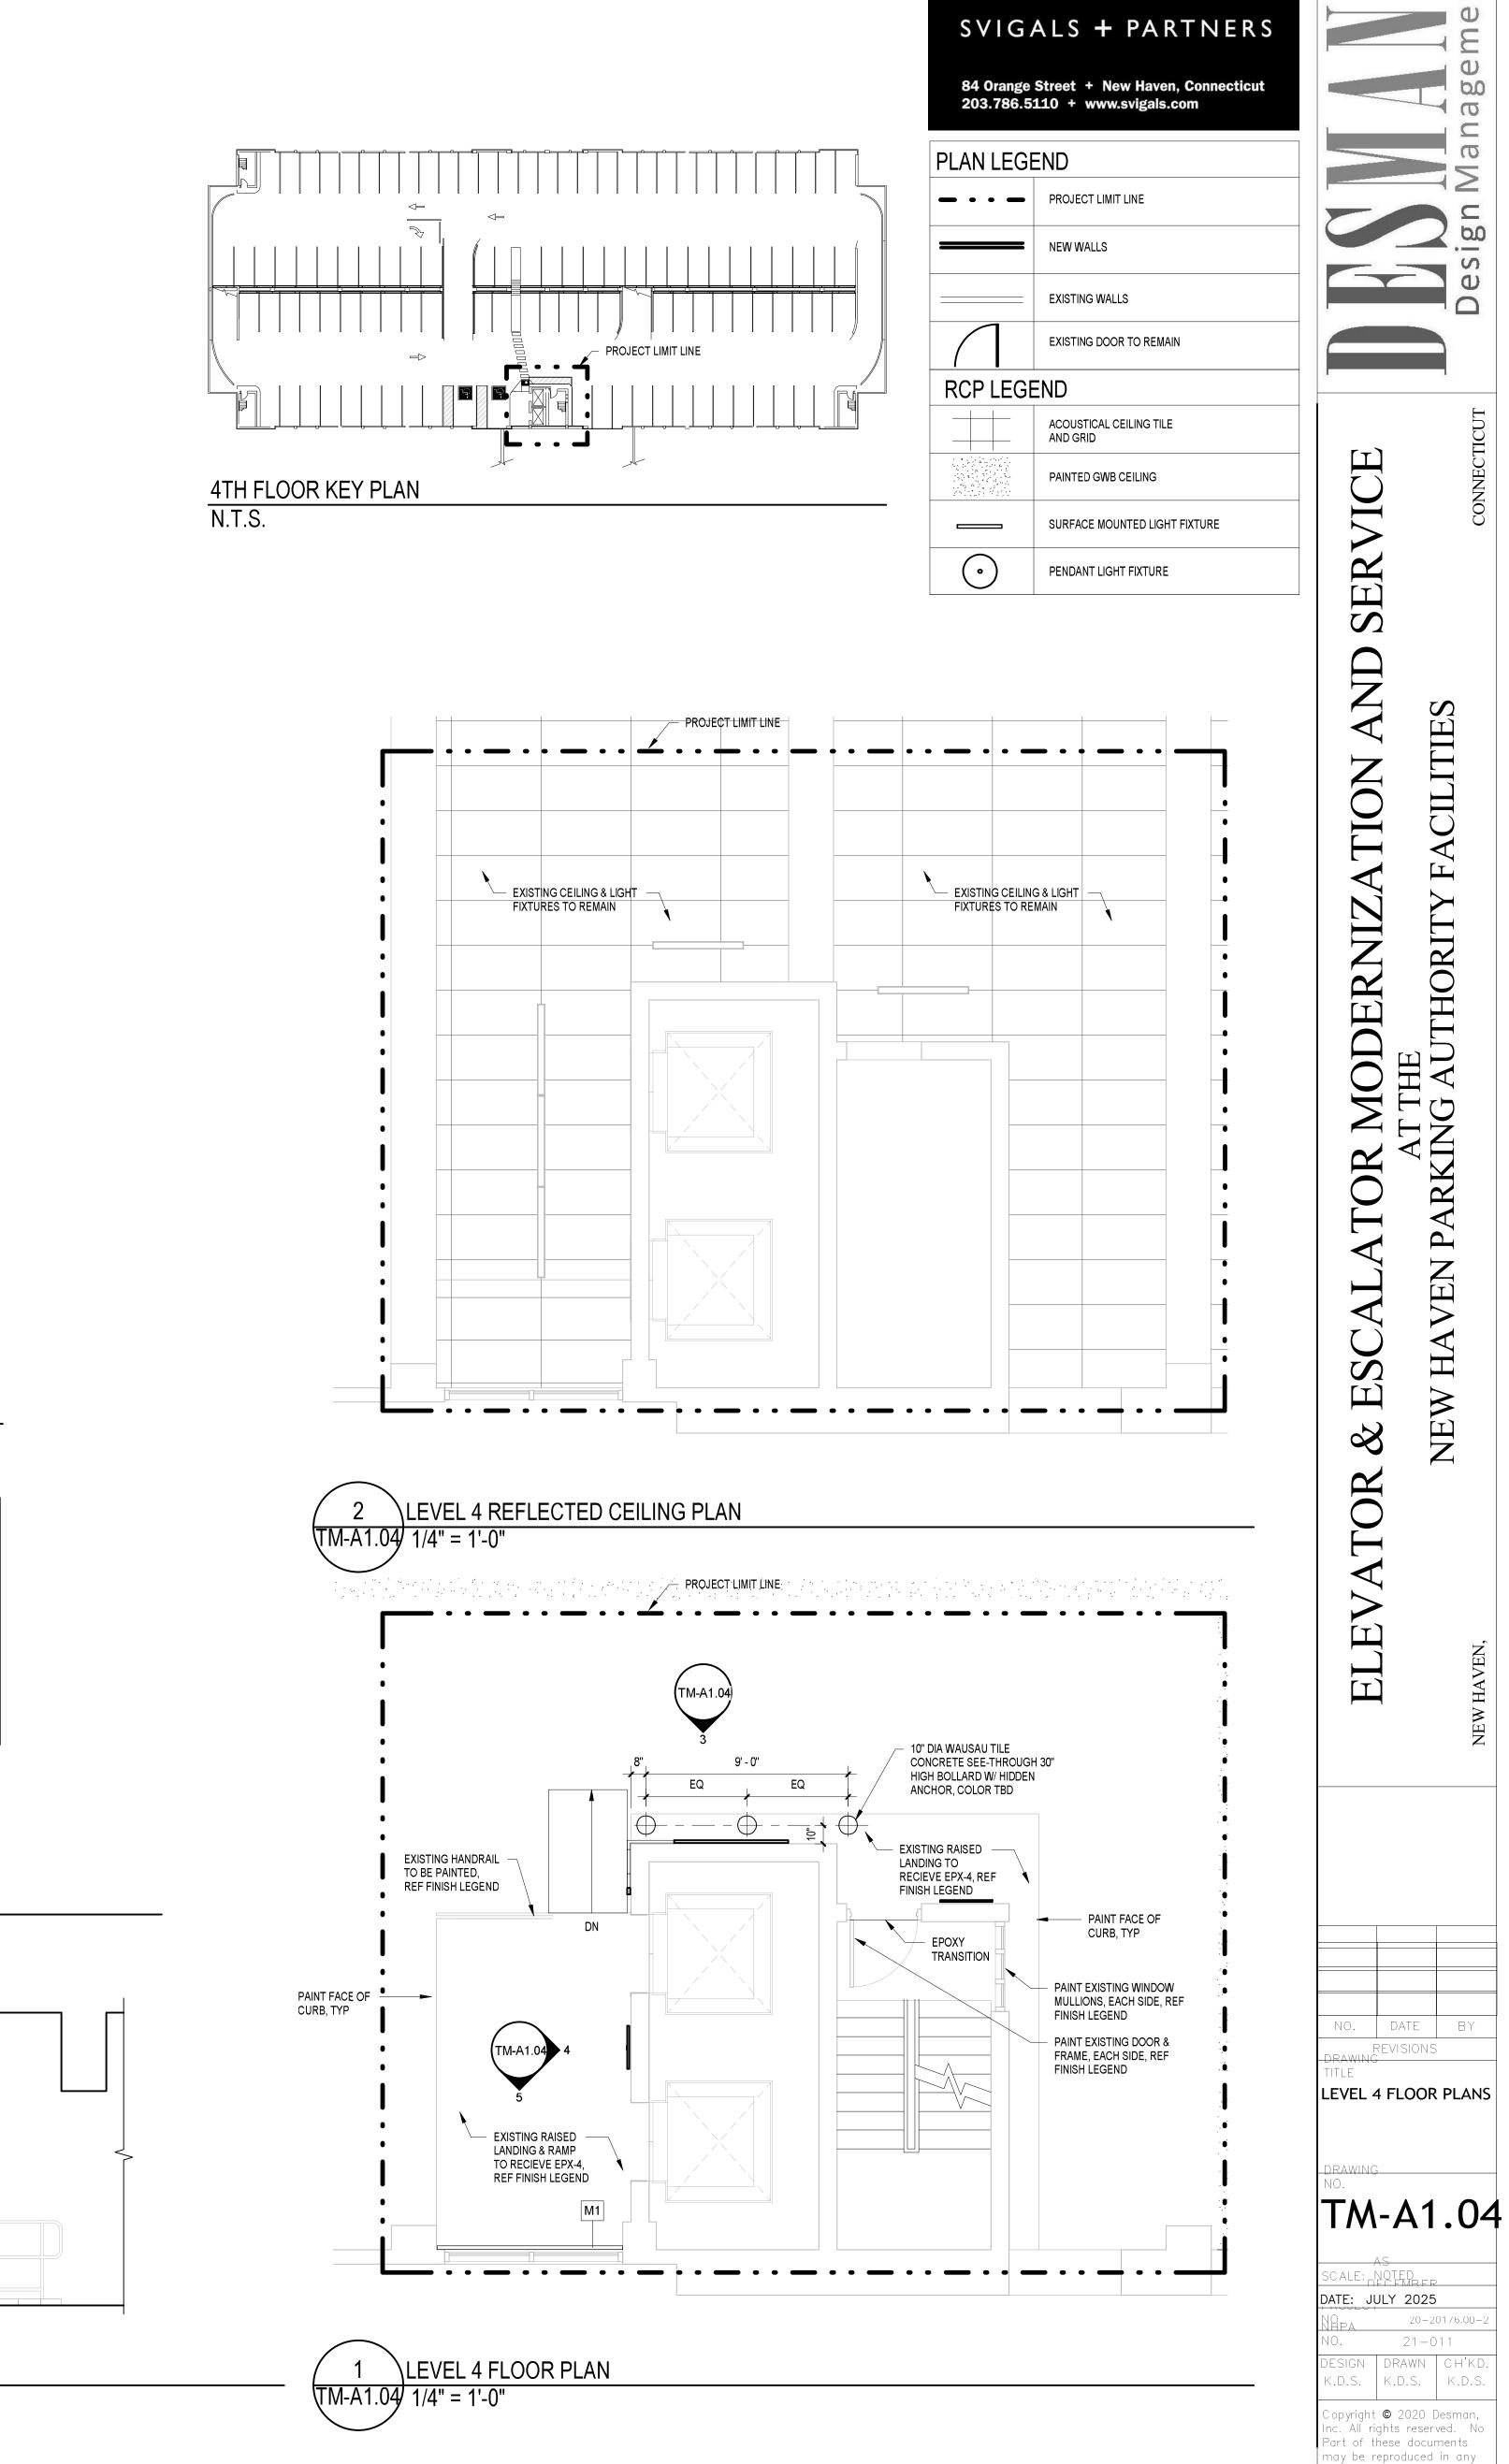
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PLAN LEGEND PROJECT LIMIT LINE **NEW WALLS** EXISTING WALLS EXISTING DOOR TO REMAIN RCP LEGEND ACOUSTICAL CEILING TILE AND GRID

NO. DATE BY REVISIONS LEVEL 3 FLOOR PLANS

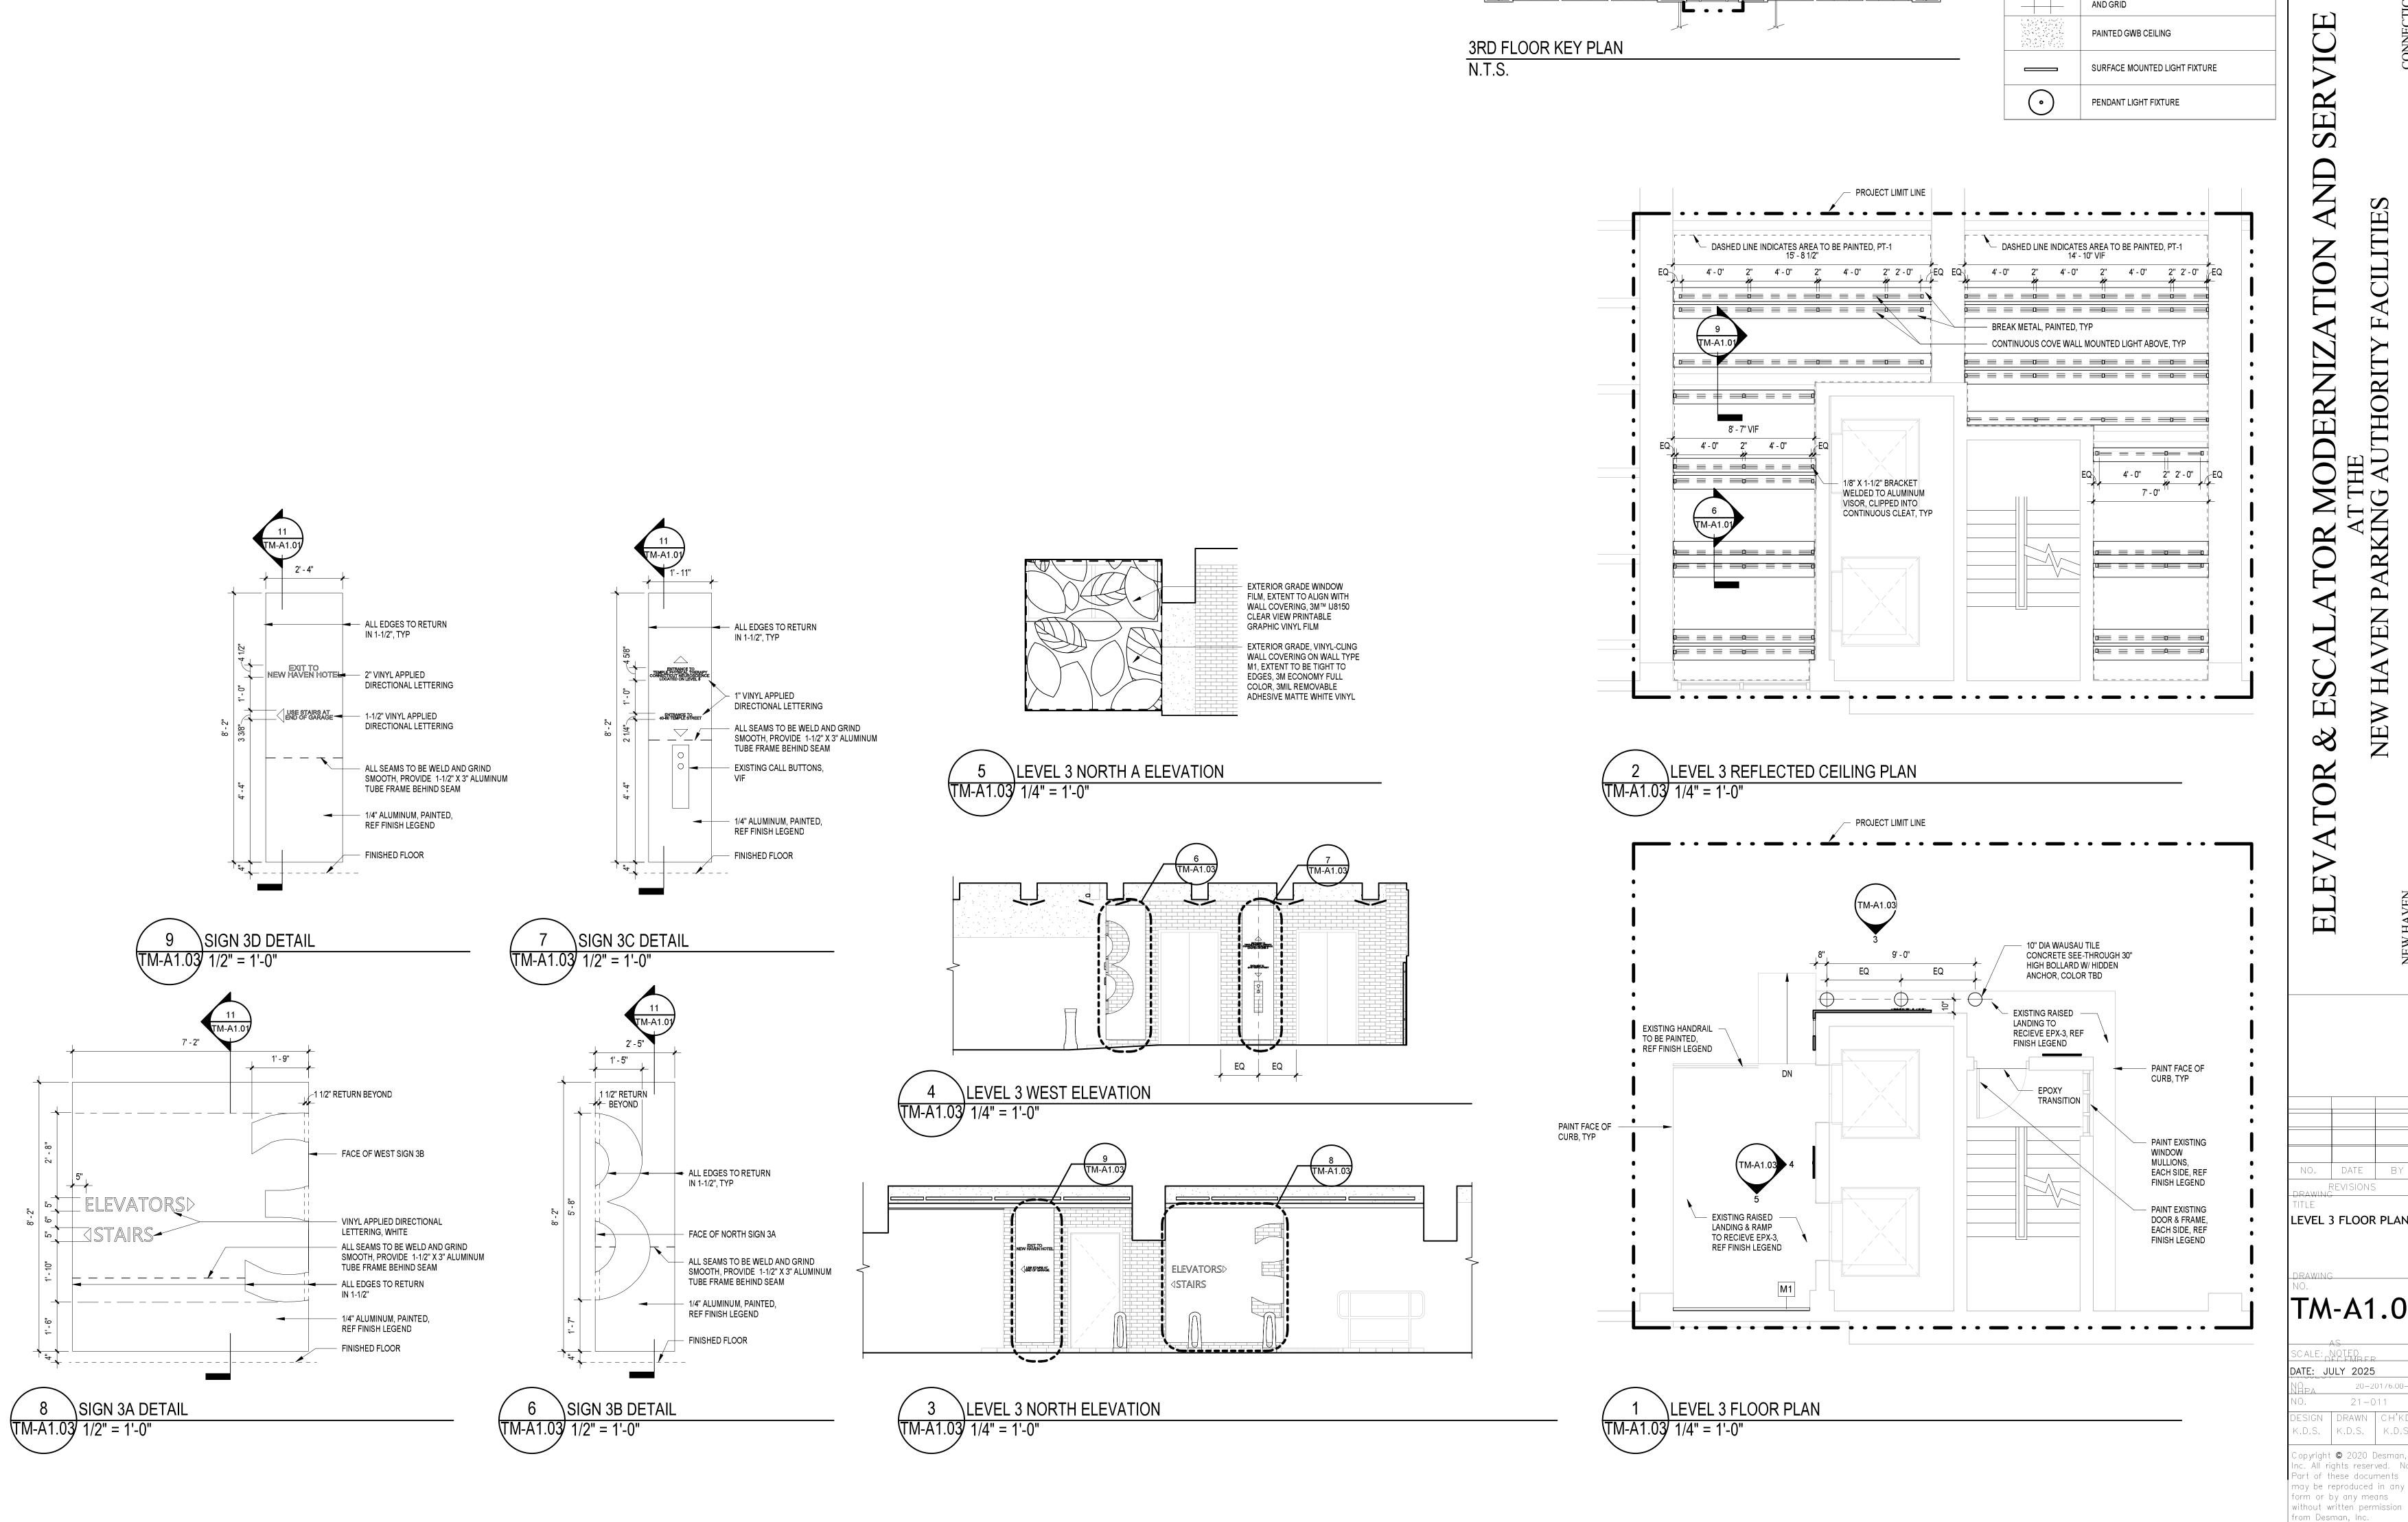TM-A1.03

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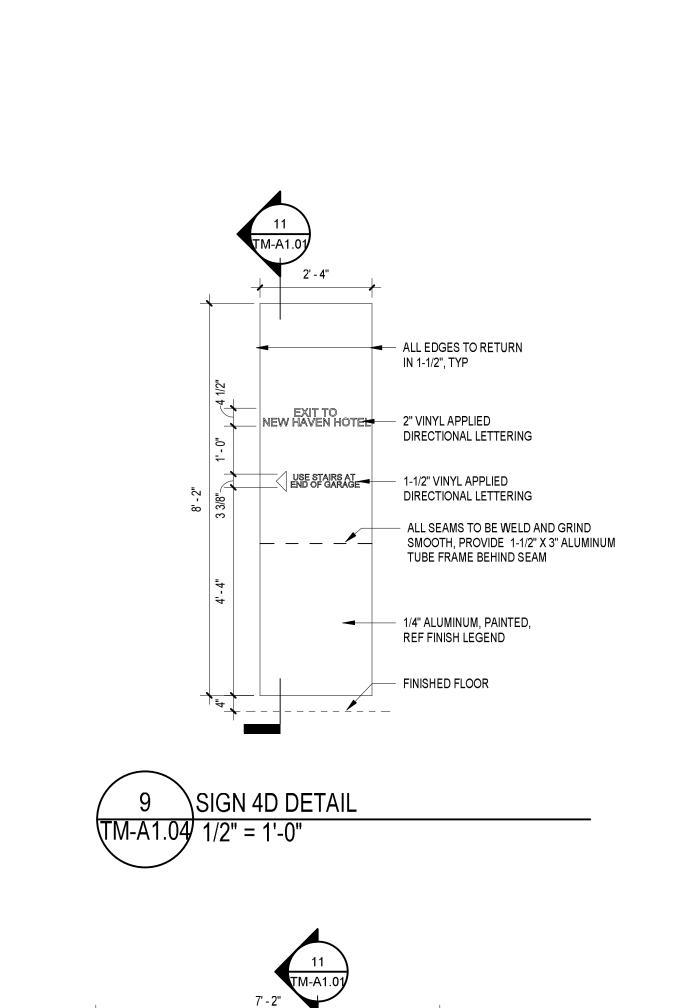
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REVISIONS

20-201/6.00-2

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2' - 1"

4-----

SIGN 4A DETAIL

TM-A1.04/ 1/2" = 1'-0"

FACE OF WEST SIGN 4B

VINYL APPLIED DIRECTIONAL

TUBE FRAME BEHIND SEAM

- ALL SEAMS TO BE WELD AND GRIND SMOOTH, PROVIDE 1-1/2" X 3" ALUMINUM

LETTERING, WHITE


ALL EDGES TO RETURN
IN 1-1/2", TYP

——— 1/4" ALUMINUM, PAINTED,

- FINISHED FLOOR

REF FINISH LEGEND

-1 1/2" RETURN BEYOND

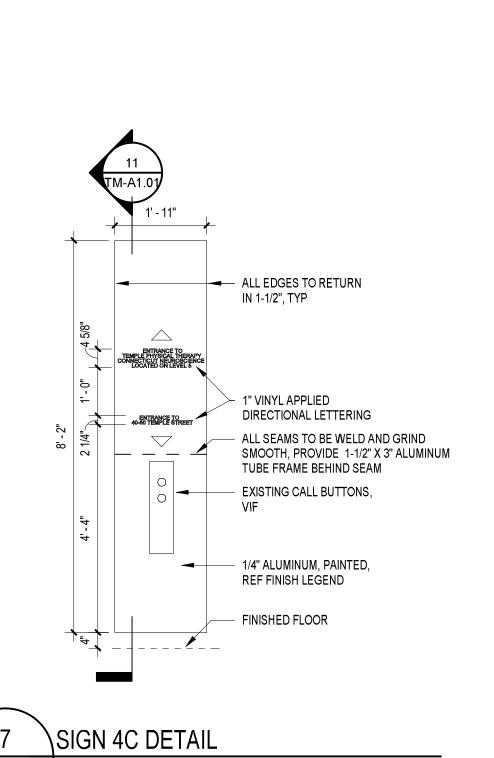

1 1/2" RETURN

ALL EDGES TO RETURN

IN 1-1/2", TYP

→ 1/4" ALUMINUM, PAINTED,


FACE OF NORTH SIGN 4A

ALL SEAMS TO BE WELD AND GRIND SMOOTH, PROVIDE 1-1/2" X 3" ALUMINUM

TUBE FRAME BEHIND SEAM

REF FINISH LEGEND

- FINISHED FLOOR

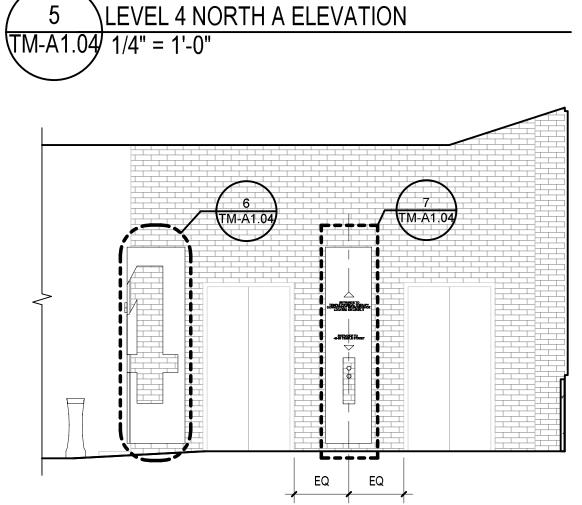


EXTERIOR GRADE WINDOW FILM, EXTENT TO ALIGN WITH WALL COVERING, 3M™ IJ8150 CLEAR VIEW PRINTABLE

EXTERIOR GRADE, VINYL-CLING WALL COVERING ON WALL TYPE M1, EXTENT TO BE TIGHT TO


EDGES, 3M ECONOMY FULL COLOR, 3MIL REMOVABLE


ADHESIVE MATTE WHITE VINYL


GRAPHIC VINYL FILM

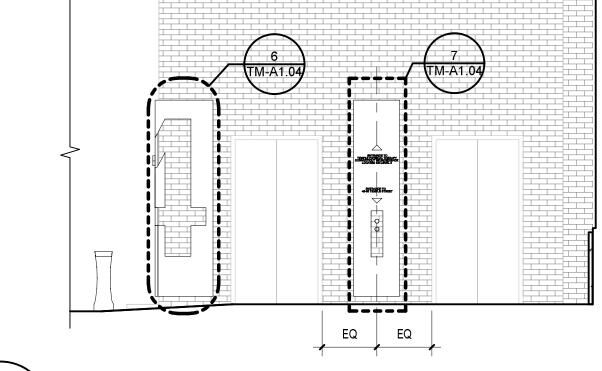



LEVEL 4 WEST ELEVATION

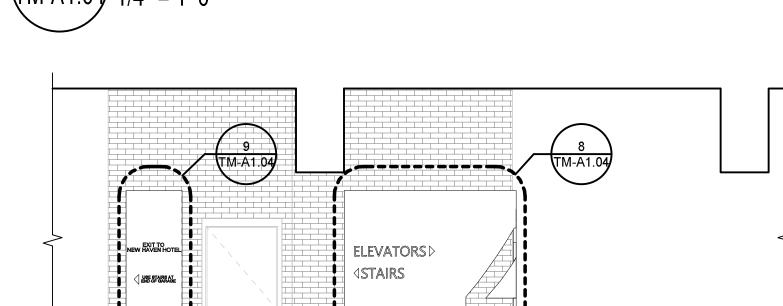

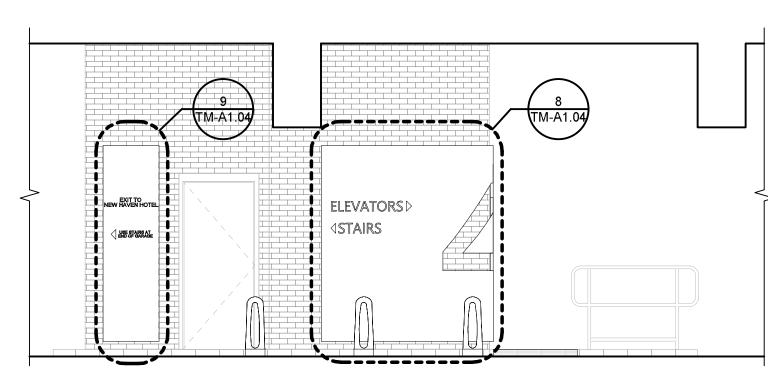

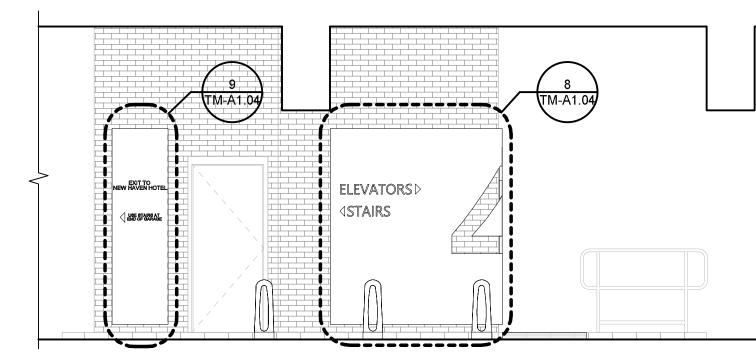

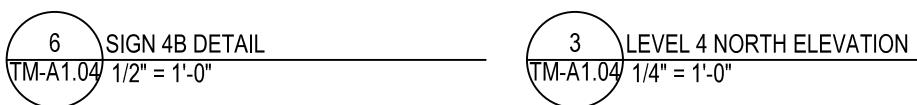

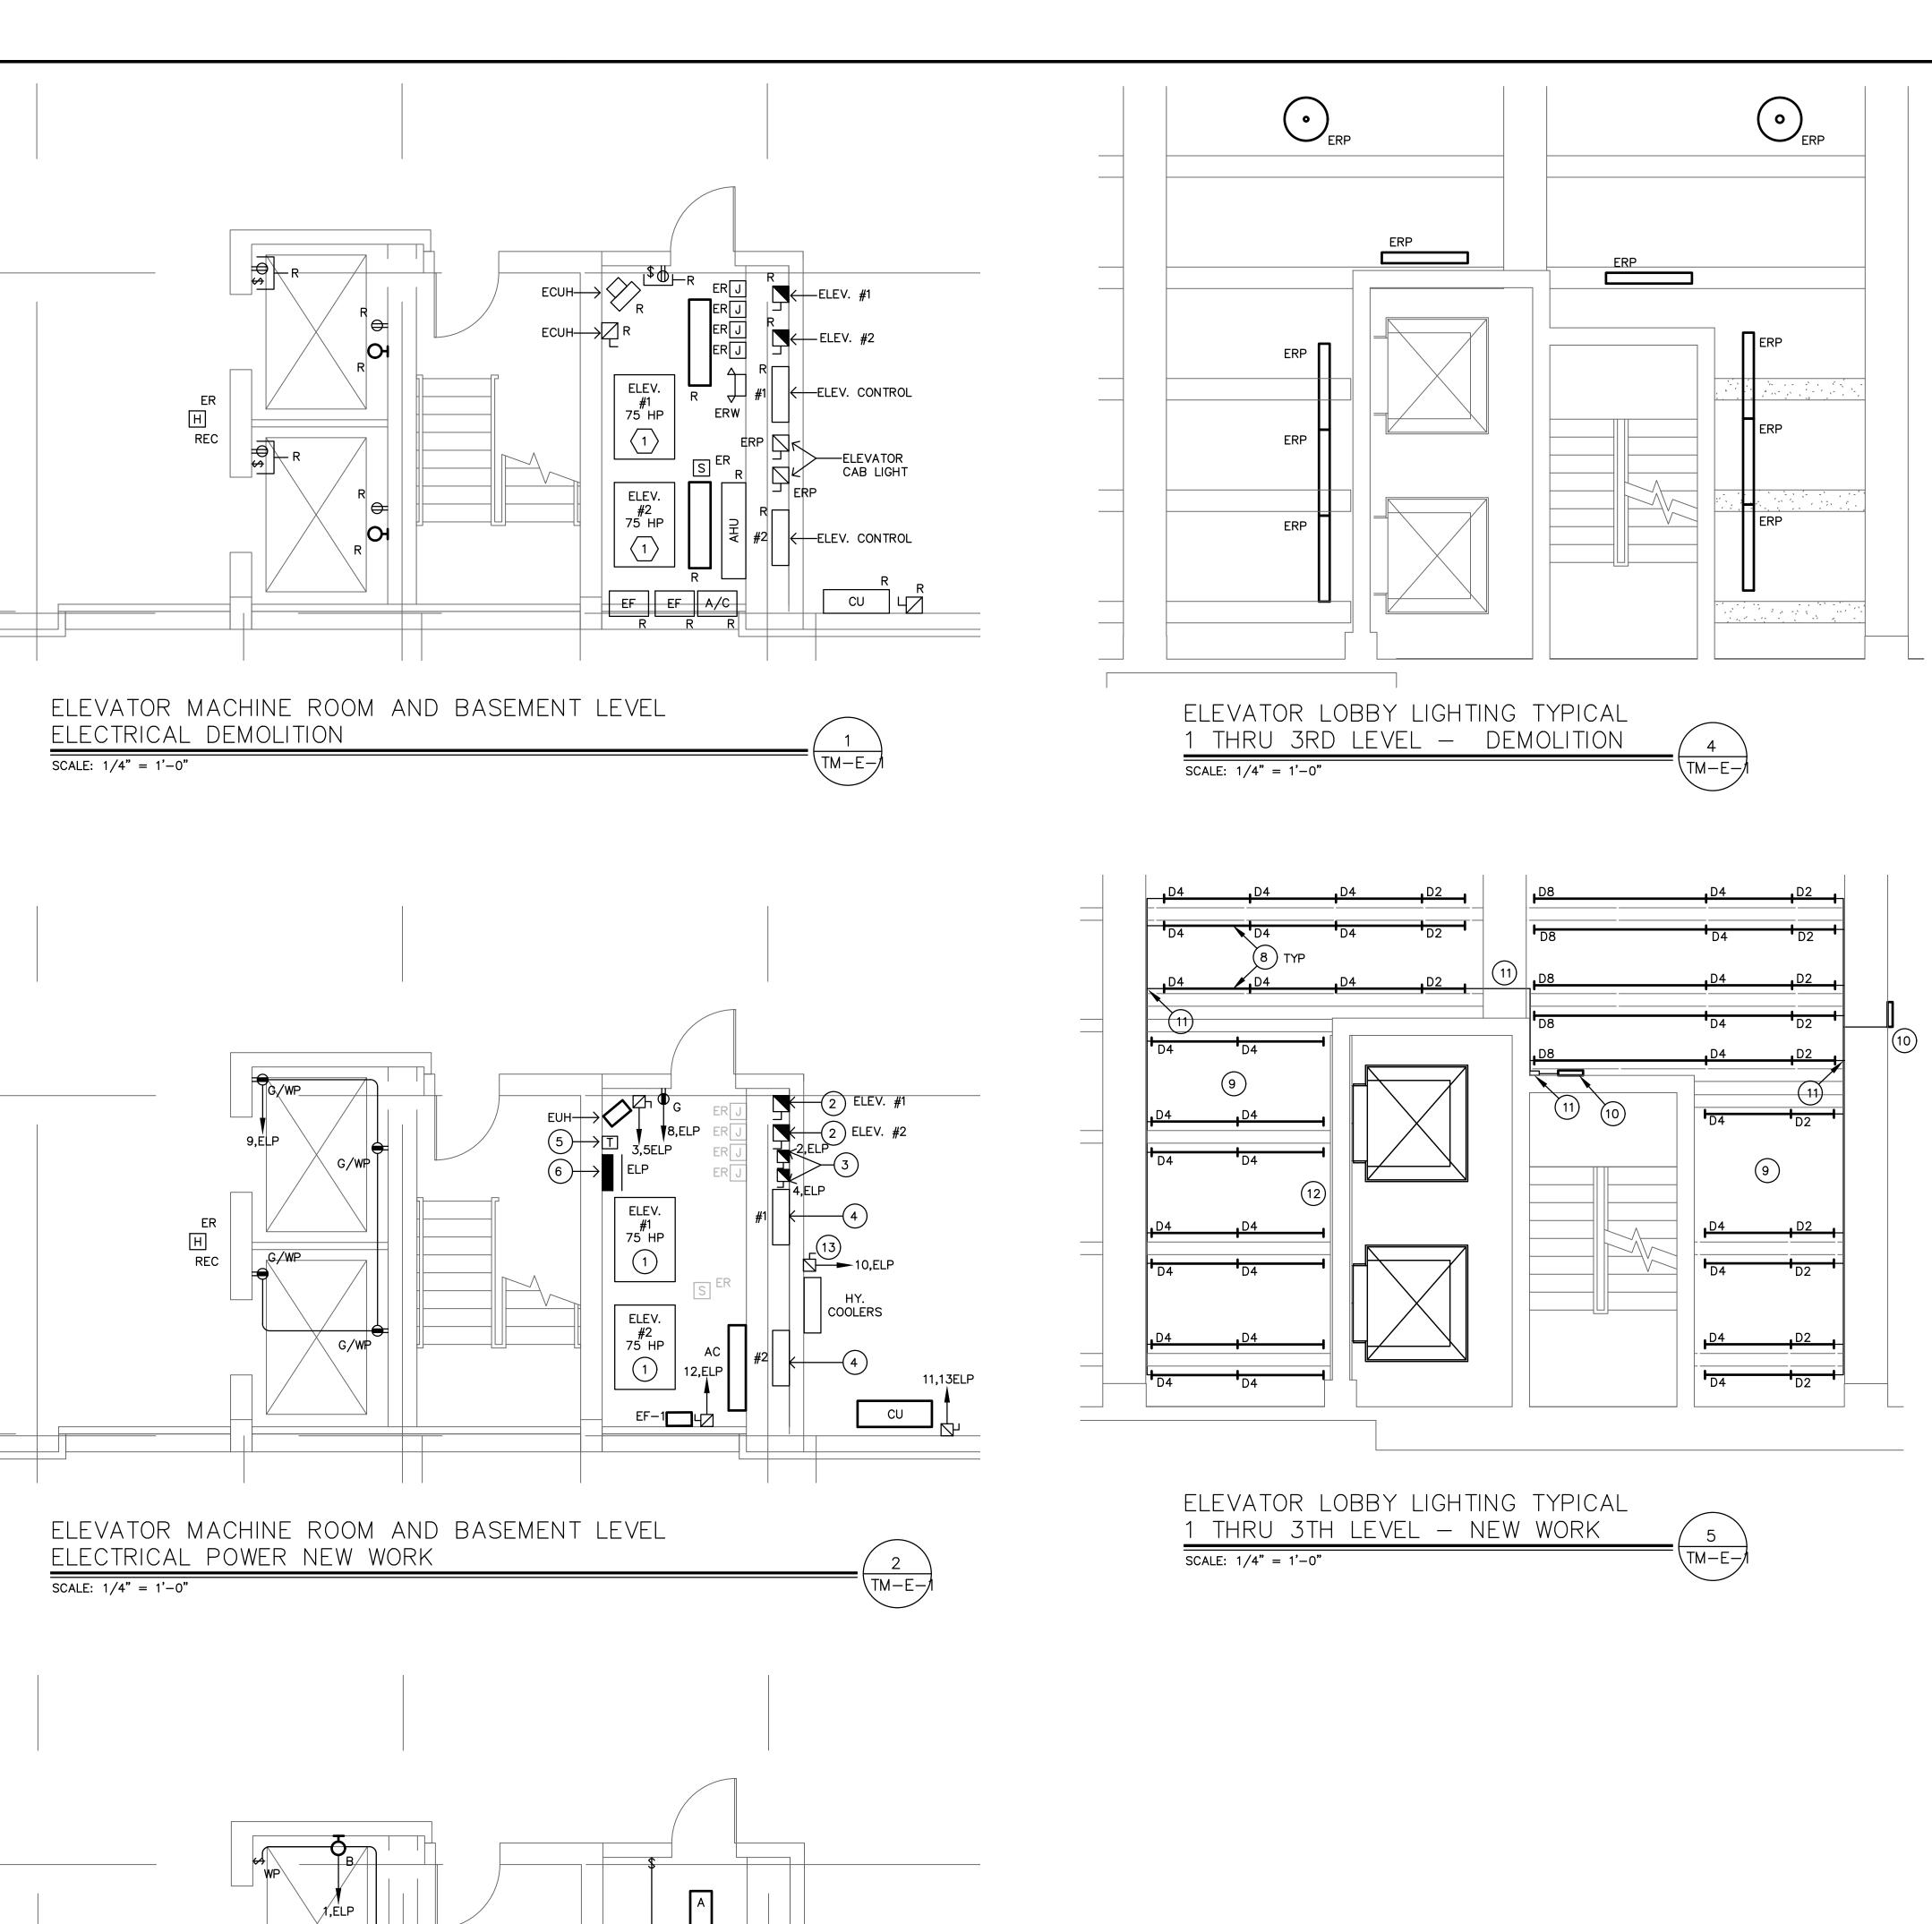


6,ELP **←**

 $\TM-E-$

ELEVATOR MACHINE ROOM AND

SCALE: 1/4" = 1'-0"

BASEMENT LEVEL ELECTRICAL LIGHTING NEW WORK

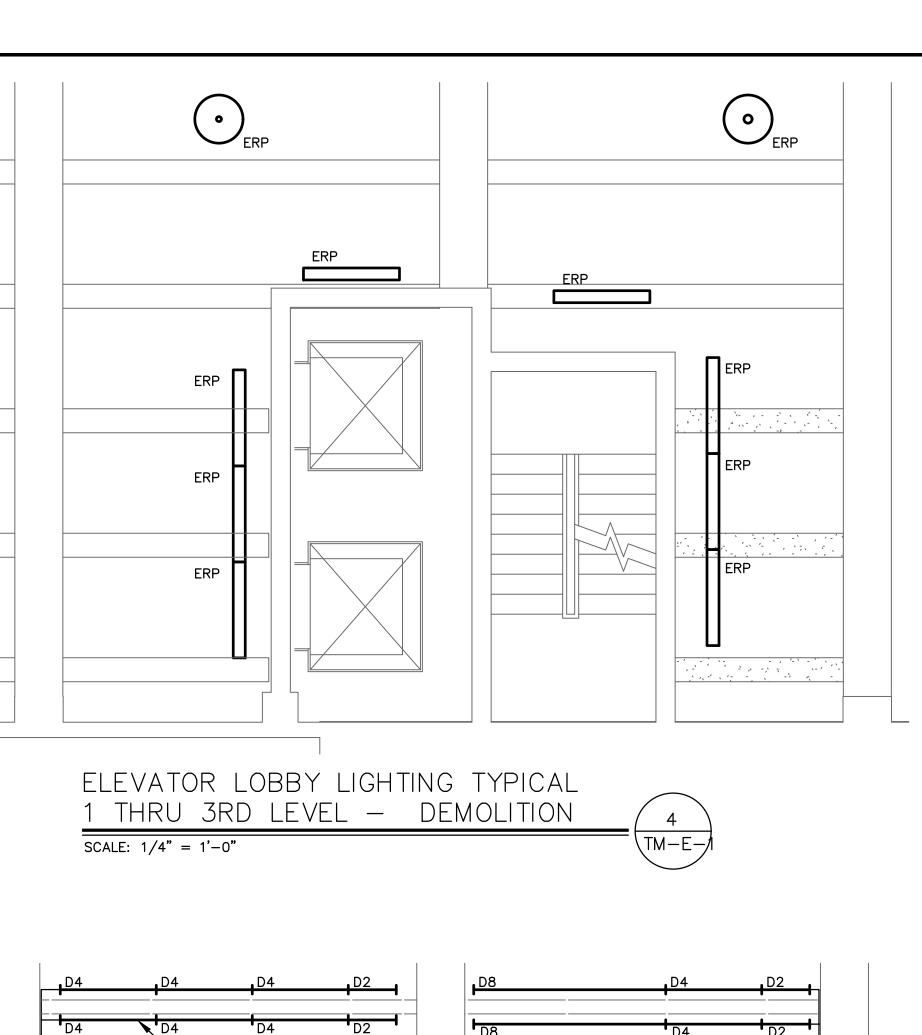



APPROXIMATE LOCATION OF EXISTING ELEVATOR MOTOR TO BE DISCONNECTED BY ELECTRICAL CONTRACTOR. REMOVE ASSOCIATED WIRING AND CONDUIT BACK TO DISCONNECT SERVING ELEVATOR..

DEMOLITION ABBREVIATION

- ER EXISTING TO REMAIN (UNLESS OTHERWISE INDICATED, SHOWN FOR REFERENCE PURPOSE ONLY).
- ERP EXISTING UNIT/DEVICE AND ASSOCIATED ACCESSORIES TO BE REPLACED AT NEW LOCATION, EXTEND ASSOCIATED WIRING AND CONDUIT TO NEW LOCATION. REFER TO NEW WORK FOR ADDITIONAL INFORMATION.
- ERW EXISTING UNIT/DEVICE TO BE REPLACED AT SAME LOCATION. CONTRACTOR TO RETAIN ASSOCIATED WIRING AND CONDUIT TO SUIT NEW. REFER TO NEW WORK FOR ADDITIONAL INFORMATION.
- EXISTING TO BE REMOVED. CONTRACTOR TO REMOVE ASSOCIATED DEVICES, WIRING AND CONDUIT BACK TO SOURCE

DEMOLITION GENERAL NOTES

- UNLESS OTHERWISE INDICATED, THE ELECTRICAL CONTRACTOR SHALL REMOVE ALL INDICATED ELECTRICAL EQUIPMENT, ACCESSORIES, CONTROLS, DEVICES, AND ASSOCIATED CONDUIT AND WIRING BACK TO SOURCE OR LAST DEVICE.
- . NO EQUIPMENT OR DEVICES THAT HAVE BEEN DISCONNECTED AND/OR ABANDONED SHALL REMAIN.
- THE ELECTRICAL CONTRACTOR SHALL VISIT THE SITE AND BECOME FAMILIAR WITH THE EXISTING SYSTEMS AND CONDITIONS IN AREAS OF
- ANY SYSTEMS OR EQUIPMENT TO REMAIN ACTIVE DURING RENOVATION SHALL BE KEPT IN OPERATION BY PROVIDING TEMPORARY CONNECTIONS

RENOVATION.

THE ELECTRICAL CONTRACTOR SHALL COORDINATE WITH THE OWNER, CM, AND/OR GENERAL CONTRACTOR ANY AND ALL PHASING OF THE MECHANICAL DEMOLITION WORK IN ORDER TO SATISFY THE CONSTRUCTION SCHEDULE AND OWNER'S OCCUPANCY REQUIREMENTS.

AS REQUIRED UNTIL NEW SYSTEMS ARE INSTALLED AND OPERATIONAL.

- ANY ELECTRICAL EQUIPMENT TO BE REMOVED AND REUSED OR TURNED OVER TO THE OWNER, AT OWNERS REQUEST, OR AS INDICATED ON THE DRAWINGS SHALL BE CAREFULLY REMOVED AND STORED TO PREVENT
- THE ELECTRICAL CONTRACTOR SHALL ALSO REVIEW THE ARCHITECTURAL DEMOLITION DRAWINGS AS PART OF THIS CONTRACT FOR ADDITIONAL INFORMATION AND REQUIREMENTS.
- 8. ALL SERVICE INTERRUPTIONS SHALL BE COORDINATED AND APPROVED WITH THE OWNER IN ADVANCE PRIOR TO COMMENCEMENT OF ANY WORK.
- 9. THE ELECTRICAL CONTRACTOR SHALL COORDINATE HIS DEMOLITION WORK WITH THAT OF OTHER TRADES IN ORDER TO AVOID CONFLICTS.
- 10. ELECTRICAL COMPONENTS SHOWN ON THE DEMOLITION DRAWINGS, AND THE ASSOCIATED CONDUIT. WIRE & BOXES ARE TO BE REMOVED AND DISPOSED OF UNLESS SPECIFICALLY NOTED OTHERWISE.
- 11. ALL MATERIALS BEING REMOVED SHALL BE HANDLED IN A MANNER COMPLYING WITH ALL PERTINENT LAWS, CODES AND ENVIRONMENTAL REGULATIONS.
- 12. ALL REMOVED COMPONENTS SHALL BE LEGALLY DISPOSED OF BY
- CONTRACTOR UNLESS SPECIFICALLY NOTED OTHERWISE. 13. WHERE EXISTING DEVICES ARE REMOVED & NO NEW DEVICES ARE

PROVIDE PROPERLY SIZED BLANK COVER PLATE.

RELOCATED TO MAINTAIN CONTINUATION OF SERVICES.

14. WHERE ELECTRICAL EQUIPMENT & DEVICES ARE BEING REMOVED, COORDINATE AND FIELD VERIFY IF BRANCH CIRCUIT FEEDS THROUGH TO EQUIPMENT/DEVICES TO REMAIN. BRANCH CIRCUITS SHALL BE SPLICED OR

INSTALLED IN THE SAME LOCATION, REMOVE ALL WIRING FROM BOX &

- NEW ELEVATOR MACHINE WITH MOTOR TO BE PROVIDED BY ELEVATOR INSTALLER. CONTRACTOR TO WIRE MOTOR RATED FOR 75 HP TO CORRESPONDING ELEVATOR DISCONNECT
- PROPOSED LOCATION FOR FUSED DISCONNECT SWITCH RATED FOR 200AMP-3P WITH 125AMP FUSE, 480V-3PHASE TO SUIT ELEVATOR DISCONNECT SHALL BE LOCKABLE IN THE OPEN POSITION. PROVIDE AUXILIARY CONTACT WITHIN DISCONNECT TO BE INTERCONNECTED WITH ELEVATOR CONTROLLERS. INTERCONNECT DISCONNECT WITH ELEVATOR MOTOR AND EXISTING FEEDER. PROVIDE 125A-3P CIRCUIT BREAKER, 2"C, 4#1 IN EXISTING PANEL IF EXISTING FEEDER AND BREAKER IS NOT COMPATIBLE WITH NEW CONNECTION. PROVIDE ALL COMPONENTS NECESSARY FOR A COMPLETE MANUFACTURER / ENGINEER APPROVED INSTALLATION TO BE FULLY OPERATIONAL.
- PROPOSED NEW LOCATION FOR FUSED DISCONNECT SWITCH RATED FOR 30A, 120V-1 PHASE TO SUIT CAB LIGHTING AND VENTILATION. DISCONNECT SHALL BE LOCKABLE IN THE OPEN POSITION. INTERCONNECT WITH CAB LIGHTING, VENTILATION AND EXISTING BRANCH CIRCUIT. PROVIDE ALL COMPONENTS NECESSARY FOR A COMPLETE MANUFACTURER / ENGINEER APPROVED INSTALLATION TO BE FULLY OPERATIONAL.
- NEW ELEVATOR CONTROLLER TO BE PROVIDED AND INSTALLED BY ELEVATOR INSTALLER. CONTRACTOR TO INTERCONNECT UNIT WITH CORRESPONDING ELEVATOR DISCONNECT AND PROVIDE ASSOCIATED WIRING AND CONDUIT.
- PROPOSED LOCATION FOR NEW WALL MOUNT STEP-DOWN TRANSFORMER RATER FOR 15KVA, 480-120/240-1PH. MOUNT AND

WIRE AS PER MANUFACTURER REQUIREMENTS.

- PROPOSED LOCATION FOR NEW ELECTRICAL PANEL RATED FOR 60A, 120/240V-1PH. REFER TO PANELBOARD SCHEDULE AND ONE-LINE RISER DIAGRAM FOR ADDITIONAL INFORMATION.
- CONNECT TO ROOM LIGHTING CIRCUIT AHEAD OF SWITCHING DEVICE.
- SURFACE LED STRIP LINEAR FIXTURE TO BE MOUNTED ALONG EACH SIDE OF STRUCTURE/BEAM. RECONNECT TO EXISTING LOCAL SWITCHING LIGHTING AND BRANCH CIRCUIT. REFER TO LIGHTING FIXTURE SCHEDULE FOR ADDITIONAL INFORMATION.
- ALL CONDUITS WITHIN THIS AREA SHALL BE CONCEALED AND NEATLY INSTALLED. ADJUST ROUTING AS REQUIRED TO CONCEALED CONDUITS. REFER TO DETAIL ON TM-E-2 FOR TYPICAL CONNECTION TO LINEAR FIXTURES. ALSO SEE NOTE #11.
- MAINTAIN CIRCUIT CONNECTION TO EXISTING EXIT SIGN.
- LIGHTING CIRCUIT FEEDS OUT OF STAIR AT THIS LOCATION. EXTEND FROM HERE TO THE FIRST ROW OF LINEAR FIXTURES. FEED THROUGH THAT LINE TO THE MAJOR BEAM TO THE EAST AND REFER TO DETAIL ON TM-E-2 FOR TYPICAL CONNECTION. CROSS THE MAJOR BEAM TO THE WEST AND CONNECT TO THE ROW OF LINEAR FIXTURES AT THAT POINT. FEED THRU TO MAJOR BEAM TO THE WEST AND REFER TO THE TYPICAL CONNECTION DETAIL.
- FIRE ALARM PULL STATION AND HORN/STROBE NEAR STAIR DOOR TO REMAIN. CONTRACTOR SHALL REWORK CONDUIT AND WIRE FROM THAT POINT TO THE ELEVATOR RECALL HEAT DETECTOR. PROVIDE NEW CONDUIT ROUTE ATTACHED TO THE BRICK WALL SURFACE.
- PROVIDE 120V, 20A DEDICATED BRANCH CIRCUIT AND NEMA 3R DISCONNECT FOR HYDRAULIC COOLERS FURNISHED WITH ELEVATOR.

NEW WORK ABBREVIATION

- ER EXISTING TO REMAIN (UNLESS OTHERWISE INDICATED, SHOWN FOR REFERENCE
- REW REPLACED EXISTING UNIT/DEVICE AT SAME LOCATION. RECONNECT TO EXISTING WIRING AND CONDUIT.

DRAWING GENERAL NOTES

- ONLY LINE VOLTAGE WIRING RATED FOR 120V SERVING ELEVATOR DEVICES CAN BE INSTALLED WITHIN ELEVATOR HOISTWAY. PROVIDE SHUNT-TRIP BREAKER FOR ALL CIRCUIT BREAKER SERVING ELEVATOR WITH SPRINKLER HEAD IN THE ELEVATOR HOISTWAY.
- ELECTRICAL CONTRACTOR ASSUMES ALL RESPONSIBILITY DURING CONSTRUCTION TO PROTECT MATERIALS AND EQUIPMENT. ANY & ALL DAMAGED ITEMS & EQUIPMENT DURING CONSTRUCTION SHALL BE REPLACED AT NO ADDITIONAL COST TO THE OWNER. ALL PANEL DIRECTORIES AFFECTED BY RENOVATION SHALL BE UPDATED WITH NEW CIRCUIT BREAKER DESIGNATION
- ALL CIRCUIT BREAKERS SERVING ELEVATOR SHALL BE PROVIDED WITH LOCK TAB. 6. DESIGN WAS DEVELOPED BASED ON THE BEST AVAILABLE INFORMATION PROVIDED IN ELECTRICAL PANELBOARD DIRECTORY. CONDUITS AND FEEDERS COULD NOT BE TRACED. CONTRACTOR MUST TRACE ELEVATOR FEEDERS AND NOTIFY ENGINEER OF ANY DISCREPANCY WITH DRAWINGS PRIOR STARTING PROJECT.

RATINGS: 60A MCB 22,000 AIC SERVICE: 120/240V,		4-WIR	Έ		$\vdash F$	/ 1/	L	L	Ε	LF	,				TION: MACHINE ROO
DESCRIPTION	NOTE	AMPS	TRIP AMP	POLE	CKT. TYP	CKT. NO.	_ A	В	CKT. NO.	CKT. TYP	POLE	TRIP AMP	AMPS	NOTE	DESCRIPTION
PIT LIGHTING		6	20	1	Α	1	-	\pm	2	Α	1	20	2		CAR 1 LIGHT
EUH		36	45	2	В	3		+	4	Α	1	20	2		CAR 2 LIGHT
		36	40			5	-	\pm	6	Α	1	20	2.5		E.M.R. LIGHTING
INTAKE LOUVER		2	20	1	Α	7		+	8	Α	1	20	1.5		E.M.R. RECEPTACLE
PIT RECEPTACLES		2	20	1	_	9	+		10	Α	1	20	3		HYDRAULIC COOLER
CU/AC		16	25	2	В	11		+	12	Α	1	20	5		EF-1
		16	20			13	-	$\exists _$	14	_	1	20	0		SPARE
SPARE		0	20	1	_	15	\vdash	+	16	_	1	20	0		SPARE
SPACE		0	ı	1	_	17	1	\exists	18	_	1	_	0		SPACE
SPACE		0	ı	1	_	19		+	20	_	1	-	0		SPACE
SPACE		0	ı	1	_	21	+	$\exists _$	22		1	Ī -	0		SPACE
SPACE		0		1		23		\perp	24		1		0		SPACE

NOTES:

- (1) PROVIDE CB LOCK.
- UPGRADE WIRE SIZE AS REQUIRED TO MAINTAIN 3% MAXIMUM VOLTAGE DROP.
- 3. TOTAL CONNECTED LOAD: PHASE A $^{47}_{9}$ KVA BASED ON 44 AMPS/PHASE PHASE B 4)
- 4. CIRCUIT TYPE A: 120V, 3 WIRE IN CONDUIT OR MC CABLE. CIRCUIT TYPE B: 240V, 1ø, 4 WIRE IN CONDUIT OR MC CABLE.

DRAWING TITLE TEMPLE MEDICAL-ELECTRICAL

NO. DATE BY REVISIONS

MODERNIZ AT THE ING AUTHORIT

8

H

DRAWING NO. TM-E-1

SCALE: AS NOTED

DATE: JULY 2025 PROJECT NO. 20-20176.00-2 NHPA NO. 21-011 DESIGN DRAWN CH'KD J.R.P. J.R.P. R.R.B.

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5. ALL WORK SHALL BE DONE IN ACCORDANCE WITH THE STANDARD GENERAL CONDITIONS OF THE CONSTRUCTION CONTRACT, AIA DOCUMENT 201, LATEST EDITION. 5. ELECTRICAL CONTRACTOR SHALL INSTALL ALL EQUIPMENT IN ACCORDANCE WITH MANUFACTURERS INSTRUCTIONS AND/OR

A MINIMUM. AT NO TIME SHALL THE BUILDING/SPACE BE LEFT WITHOUT COMMERCIAL POWER IN FULL OPERATING ORDER. 8. ELECTRICAL CONTRACTOR SHALL BE RESPONSIBLE FOR TESTING OF ALL PHASES OF THE WORK AND TO DEMONSTRATE TO

7. ELECTRICAL CONTRACTOR SHALL GIVE OWNER SEVEN (7) DAYS ADVANCE NOTICE OF SHUTDOWNS. SHUTDOWNS TO BE KEPT TO

OWNER THAT THE EQUIPMENT IS IN FULL OPERATING ORDER. 9. ELECTRICAL CONTRACTOR SHALL RESTORE ALL AREAS DISTURBED TO THEIR ORIGINAL CONDITION. ELECTRICAL CONTRACTOR IS

RESPONSIBLE FOR ALL CUTTING, PATCHING, PAINTING, CLEAN-UP, ELECTRICAL DEBRIS REMOVAL AND GENERAL COORDINATION

OF THE WORK EFFORT AS REQUIRED FOR THE INSTALLATION OF THE ELECTRICAL ITEMS OF WORK. 10. THE TERM "PROVIDE" SHALL MEAN TO FURNISH AND INSTALL IN COMPLETE WORKING ORDER.

11. THE SCOPE OF WORK IS AS SHOWN ON THE PLANS AND DETAILED IN THE SPECIFICATIONS.

12. ALL THE WIRE SIZES ARE BASED ON COPPER; ALUMINUM IS NOT TO BE USED.

REQUIREMENTS FOR PROPER OPERATION AND MAINTENANCE.

LOCAL CODES.

13. ALL WIRING METHODS ARE TO BE IN ACCORDANCE WITH THE CURRENT ISSUE OF THE NATIONAL ELECTRICAL CODE. AND APPLICABLE LOCAL CODES. ALL WIRING IS TO BE IN CONDUIT, UNLESS SPECIFICALLY NOTED OTHERWISE. ALL WIRING IS TO BE CONCEALED.

14. PROVIDE INDEPENDENT SEISMIC SUPPORT OF ALL ELECTRICAL EQUIPMENT PER INTERNATIONAL BUILDING CODE.

15. ELECTRICAL CONTRACTOR SHALL SECURE ALL PERMITS AND PAY FOR ALL REQUIRED FEES.

16. ELECTRICAL CONTRACTOR SHALL WARRANT AND GUARANTEE ALL MATERIALS AND WORKMANSHIP FOR A PERIOD OF ONE (1) YEAR FROM THE DATE OF FINAL ACCEPTANCE BY THE OWNER.

17. ELECTRICAL CONTRACTOR SHALL PROVIDE PROOF OF LIABILITY AND PROPERTY INSURANCE TO THE OWNER. ALL DEDUCTIBLES SHALL BE PAID FOR BY THE ELECTRICAL CONTRACTOR IN THE EVENT OF A CLAIM.

18. PERSONNEL SAFETY IS OF PRIME IMPORTANCE. NO HAZARDOUS CONDITION MUST BE ALLOWED. EVERY CARE MUST BE TAKEN TO PROTECT CONSTRUCTION AND OTHER PERSONNEL. CLEANUP IS TO BE DONE ON A DAILY BASIS. ELECTRICAL CONTRACTOR TO REMOVE AND DISPOSE OF REFUSE FROM SITE.

19. ELECTRICAL CONTRACTOR SHALL PROVIDE SHOP DRAWINGS FOR APPROVAL FOR ALL LIGHTING FIXTURES, PANELS, SWITCHES, RECEPTACLES, ETC.

20. ELECTRICAL CONTRACTOR TO VERIFY LIGHTING FIXTURE MOUNTING REQUIREMENTS FOR VARIOUS CEILING TYPES AND ORDER APPROPRIATE HARDWARE.

21. COORDINATE EXACT PLACEMENT OF EQUIPMENT WITH ELEVATOR AND MECHANICAL PLANS, MAKE FIELD ADJUSTMENTS AS REQUIRED TO AVOID CONFLICTS, VERIFY WITH OWNER.

22. ELECTRICAL CONTRACTOR TO COORDINATE WITH ELEVATOR INSTALLER AND MECHANICAL CONTRACTOR FOR ITEMS SUPPLIED BY THE MECHANICAL/OTHER DIVISIONS BUT INSTALLED BY THE ELECTRICAL CONTRACTOR. ELECTRICAL CONTRACTOR TO REVIEW ALL THE PLANS FOR THE PROJECT FOR ELECTRICAL WORK.

23. ELECTRICAL CONTRACTOR TO VERIFY ALL EQUIPMENT POWER NEEDS WITH THE ACTUAL SHOP DRAWINGS FOR THE EQUIPMENT TO BE USED. PRIOR TO STARTING ANY ELECTRICAL WORK.

24. SPECIFICATION SECTIONS, GENERAL CONDITIONS, SUPPLEMENTAL GENERAL CONDITIONS AND DRAWINGS ARE INTEGRAL PARTS OF CONTRACT DOCUMENTS.

25. THE DISPOSAL OF ALL UNUSED EXISTING ELECTRICAL EQUIPMENT REMOVED IS A PART OF THE SCOPE OF WORK. THE ELECTRICAL CONTRACTOR SHALL DISPOSE OF ALL SUCH EQUIPMENT, INCLUDING HAZARDOUS PCB CONTAINING BALLASTS, IN A MANNER CONSISTENT WITH STATE OF CT. DEPARTMENT OF ENVIRONMENTAL PROTECTION REGULATIONS, CURRENT ISSUE.

26. SHARED NEUTRALS ARE NOT TO BE USED. PROVIDE SEPARATE NEUTRALS FOR ALL CIRCUITS.

27. PRIOR TO SUBMISSION OF BIDS GIVE WRITTEN NOTICE TO ARCHITECT AND ENGINEER OF ANY MATERIAL OR APPARATUS THAT IS INADEQUATE, UNSUITABLE FOR THE USE, IN VIOLATION OF LAWS, ORDINANCES, RULES, CODES OR ANY REGULATIONS OF AUTHORITIES HAVING JURISDICTION OR ANY NECESSARY ITEMS OF WORK THAT HAS BEEN OMITTED. CONTRACTOR AFFIRMS THAT IN ABSENT OF SUCH NOTICE, ALL SYSTEMS WILL FUNCTION SATISFACTORILY WITHOUT ADDITIONAL EXTRA COMPENSATION.

28. ALL PART NUMBERS ARE PROVIDED FOR THE CONVENIENCE OF THE CONTRACTOR. THEY ARE NOT TO BE CONSIDERED THE COMPLETE SPECIFICATION OF THE PRODUCT. THE PART NUMBER AND DESCRIPTION WILL BE THE COMPLETE SPECIFICATION. IN THE EVENT OF A DISCREPANCY BETWEEN THE TWO (2), THE MORE STRINGENT, MORE COSTLY FEATURE/PERFORMANCE WILL BE

29. FOR ALL GRADE LEVEL HVAC EQUIPMENT, THE ELECTRICAL CONTRACTOR SHALL SUPPLY A GFCI WP. 20A RECEPTACLE FOR

EQUIPMENT SERVICING. ALL DISCONNECT SWITCHES ARE TO BE HEAVY DUTY, FUSED, WEATHER PROOF (WP) DEVICES. 30. NO LOW VOLTAGE WIRING SHALL BE PERMITTED IN THE SAME RACEWAY AS POWER WIRING.

31. FURNISH & INSTALL GFCI RECEPTACLES IN ALL WET LOCATIONS.

32. PROVIDE PULL STRINGS IN ALL EMPTY RACEWAYS

33. CIRCUIT NUMBERS ARE INDICATED FOR INTENT ONLY. THE ELECTRICAL CONTRACTOR SHALL ADJUST ACCORDINGLY IN THE FIELD, TO BALANCE CIRCUITS EVENLY ON ALL PHASES.

34. MINIMUM CONDUCTOR SIZE, UNLESS OTHERWISE NOTED SHALL BE #12 FOR ALL BRANCH CIRCUIT RUNS UP TO THE FIRST OUTLET; OVER 100 FEET, #10; OVER 150 FEET, #8; INCREASE CONDUIT SIZE TO SUIT.

35. ELECTRICAL CONTRACTOR TO VERIFY LOADS, SETTINGS, OVERCURRENT PROTECTION, ETC. TO INSURE COMPATIBILITY OF EQUIPMENT.

36. NO PENETRATIONS ARE ALLOWED INTO STAIR ENCLOSURES EXCEPT AS REQUIRED FOR SERVICES UTILIZED IN THE STAIR.

37. REPAIR AND REPLACE AT NO COST TO OWNER ALL EQUIPMENT AND MATERIALS DAMAGED DURING CONSTRUCTION. 38. ELECTRICAL CONTRACTOR SHALL COORDINATE ALL DEMOLITION WITH BASE BUILDING ELECTRICIAN.

39. PRODUCTS SHALL NOT BE INSTALLED IN PROMINENT LOCATIONS UNLESS NO ALTERNATIVE EXISTS. ITEMS SHALL BE CENTERED ON WALL OR CEILING TREATMENT AND ON ONE ANOTHER AS APPLICABLE. THIS INCLUDES BUT IS NOT LIMITED TO ACCESS PANELS, LIGHTING FIXTURES, SWITCHES, THERMOSTATS, FIRE ALARM DEVICES, EXIT SIGNS, ELECTRICAL PANELS, AND ANNUNCIATOR PANELS OF ANY KIND.

40. ELECTRICAL CONDUITS & BOXES SHALL BE CONCEALED IN WALLS OR ABOVE CEILINGS WHEREVER POSSIBLE.

41. INSTALLATIONS ON EXISTING WALLS SHALL BE RUN WITH SURFACE RACEWAY PAINTED TO MATCH WALL FINISH AND SURFACE BOXES. USE METAL WIREMOLD FOR INSTALLATIONS WITHIN OCCUPIED AREAS.

42. POWER RECEPTACLES COVER PLATES SHALL BE LABELED WITH DESIGNATED PANEL AND CIRCUIT NUMBER SERVING UNIT.

LIGHTING FIXTURE SCHEDULE NOTES LAMP ELECTRICAL MANUFACTURER/ DESIGNATION DESCRIPTION COLOR MODEL NUMBER VOLTAGE DRIVER TEMP DAY-BRITE 4' LENGTH SURFACE MOUNT LINEAR LED WITH LED 4000K ELECTRONIC UNIVERSAL FSI455L840-UNV FROSTED ACRYLIC LENS DAY-BRITE 4' LENGTH SURFACE MOUNT VAPORTIGHT LED WITH ELECTRONIC LED 4000K UNIVERSAL DWAE45L840-2-UNV-MD360W DAMAGE RESISTANCE ACRYLIC LENS 2' LENGTH SURFACE MOUNT LED STRIP LUMINAIRE DAY-BRITE LED 4000K ELECTRONIC UNIVERSAL FSS230L840-UNV TO BE USE AS COVE LIGHT DAY-BRITE 4' LENGTH SURFACE MOUNT LED STRIP LUMINAIRE LED 4000K ELECTRONIC UNIVERSAL 21.8 FSS430L840-UNV TO BE USE AS COVE LIGHT TWIN HEAD EMERGENCY WALL PACK DAY-BRITE ELECTRONIC LED N/A UNIVERSAL CLU2NW

NOTES

(1) FURNISH WITH ALL REQUIRED MOUNTING HARDWARE AND CONNECTING CABLE.

(2) ALL FIXTURES SHALL BE CAPABLE OF OPERATING IN COLD TEMP (0° F).


→ EXISTING SWITCHGEAR MACHINE ROOM

MAIN ELECTRICAL ROOM ELEV.#1 ELEV.#2 100A,480V-3PH 100A,480V-3PH 100A.480V-3PH 100A.480V-3PH OA FUSED DISCONNECT /-----EXISTING WIREWAY FLOOR

DEMOLITION WORK

MACHINE ROOM \longleftrightarrow MAIN ELECTRICAL ROOM EXISTING SWITCHGEAR WIREWAY RISER LEGEND 3/4°C, 2#10, 1#10G-⊕ D2'C ,3#1, 1#6G EXISTING TO BE REMOVED. TRANSFORMER 30A / 30A 200A FUSE DISCONNECT EXISTING TO REMAIN. FUSE 480V-1PH PANEL ELP 60A MCB 1'C, 3#6, 1#10G ELEVATOR #2 24 CKT NEW EQUIPMENT TO BE INSTALLED. 125 FUSE 125 FUSE 240V-1PH 480V-3PH 480V-3PH WIREWAY FLOOR

NEW WORK ONE-LINE RISER DIAGRAM TM-E-2NOT TO SCALE

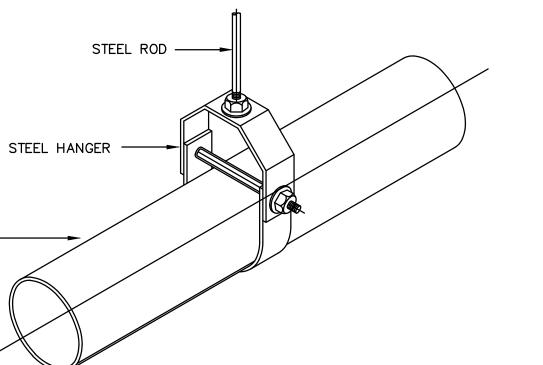

STEEL CHANNEL -

PIPE HANGER DETAIL

EXPANSION BOLT

-NUT & WASHER

- NUT & WASHER

- SETTING TUBE

STEEL HANGER


-STEEL PIPE

(NON - CORROSIVE)


- STEEL ROD

(NON - CORROSIVE)

STEEL PIPE-

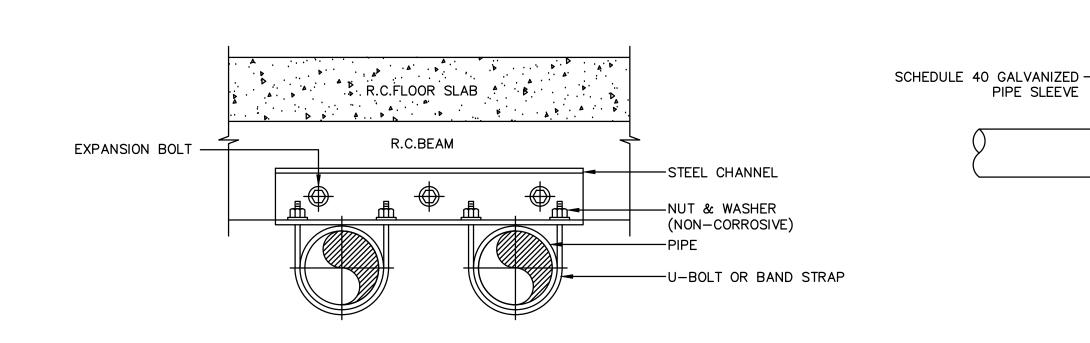




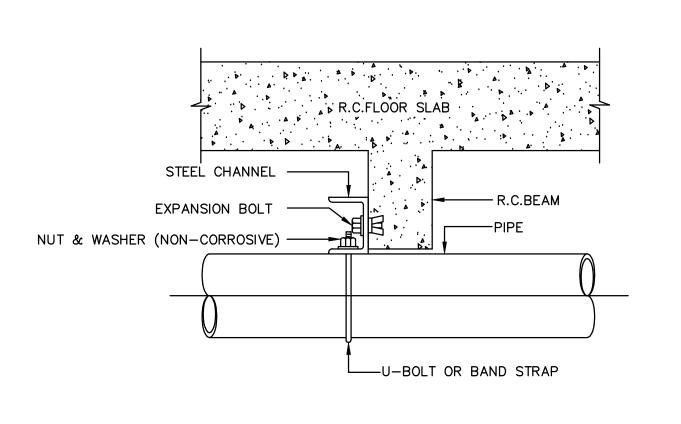

<u>ELEVATION</u>



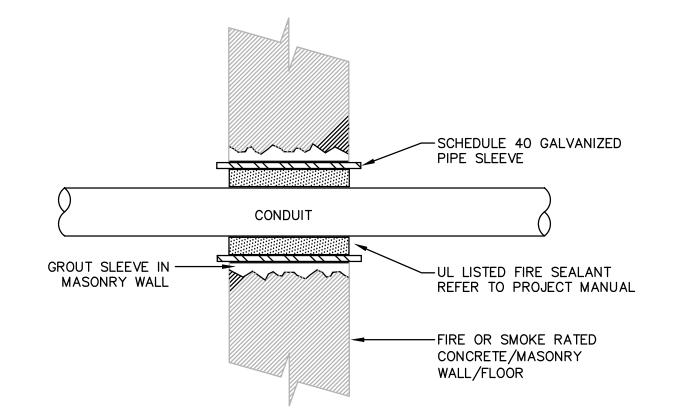

ELECTRICAL LEGEND

ABBREVIATION

CONCRETE JOIST

CONCRETE DECK

–90° CONNECTOR

-BREAKMETAL CÓVE

SEE ARCH. DWGS.

 $\TM-E-$

TO FIXTURE

-1/2" SEALTITE

─4" SQUARE WP BOX W/ SPLICE

—FIRE OR SMOKE RATED DRYWALL PARTITION

UL LISTED FIRE SEALANT

REFER TO PROJECT MANUAL

-FIRESTOP SEALANT

EXISTING PANELBOARD SURFACE MOUNTED RATED FOR 120/208V-3PH.

→ DUPLEX GROUND FAULT RECEPTACLE MOUNT 48" A.F.F.

SINGLE-POLE SWITCH; MOUNT AT 48" AFF.

\$3 SINGLE POLE THREE WAY SWITCH: MOUNT AT 48" AFF.

SINGLE-POLE PILOT SWITCH; MOUNT AT 48" AFF.

| | ENCLOSED CIRCUIT BREAKER.

FUSED DISCONNECT SWITCH.

→ DUPLEX RECEPTACLE.

CAM CAM

REC

CKT-X

NON-FUSED DISCONNECT SWITCH.

WALL MOUNTED LIGHT FIXTURE.

SECURITY CAMERA.

---- CONDUIT AND WIRE

WP WEATHERPROOF

— — CONDUIT AND WIRE, SWITCHED

GROUND FAULT INTERRUPTER

BRANCH CIRCUIT HOMERUN.

LINEAR WALL MOUNTED LIGHT FIXTURE

FIRE ALARM ADDRESSABLE RELAY

FIRE ALARM SHUNT TRIP HEAT DETECTOR.

FIRE ALARM RECALL SMOKE DETECTOR.

WALL MOUNTED FIRE ALARM HEAT DETECTOR

LINEAR LED

SCALE: 3'' = 1'-0''

PIPE SLEEVE

PULLING ELL

-CONDUIT TO NEXT JOIST

STRAP TO CONCRETE BEAM

CONDUIT

LINEAR FIXTURE CONNECTION DETAIL

FIXTURE

WALL/FLOOR PENETRATION W/FIRE-SMOKE SEAL DETAIL NOT TO SCALE **GENERAL NOTES:**

1. PROVIDE UL LISTED FIRE/SMOKE PENETRATION ASSEMBLY IN ACCORDANCE W/UL1479, ASTM E 814 REQUIREMENTS FOR WALL TYPE, RATING, PIPE SIZE

2. FIRESTOPPING SHALL HAVE A RATING EQUAL TO OR GREATER THAN THE WALL/FLOOR BEING PENETRATED - SEE PROJECT MANUAL. REFER TO DRAWINGS FOR WALL/FLOOR RATINGS AND LOCATIONS.

REVISIONS

RAWING TITLE TEMPLE MEDICAL-AND GEN. NOTES

DATE: JULY 2025 PROJECT NO. 20-20176.00-2 NHPA NO. 21-011

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ER

NO. | DATE | BY

ELECTRICAL

DRAWING NO. TM-E-2


SCALE: AS NOTED

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TM-M-1

EMR DEMOLITION PLAN SCALE: 1/4" = 1'-0"



TEMPLE MEDICAL GARAGE EMR MECHANICAL PLAN	2
SCALE: 1/4" = 1'-0"	TM-M-1

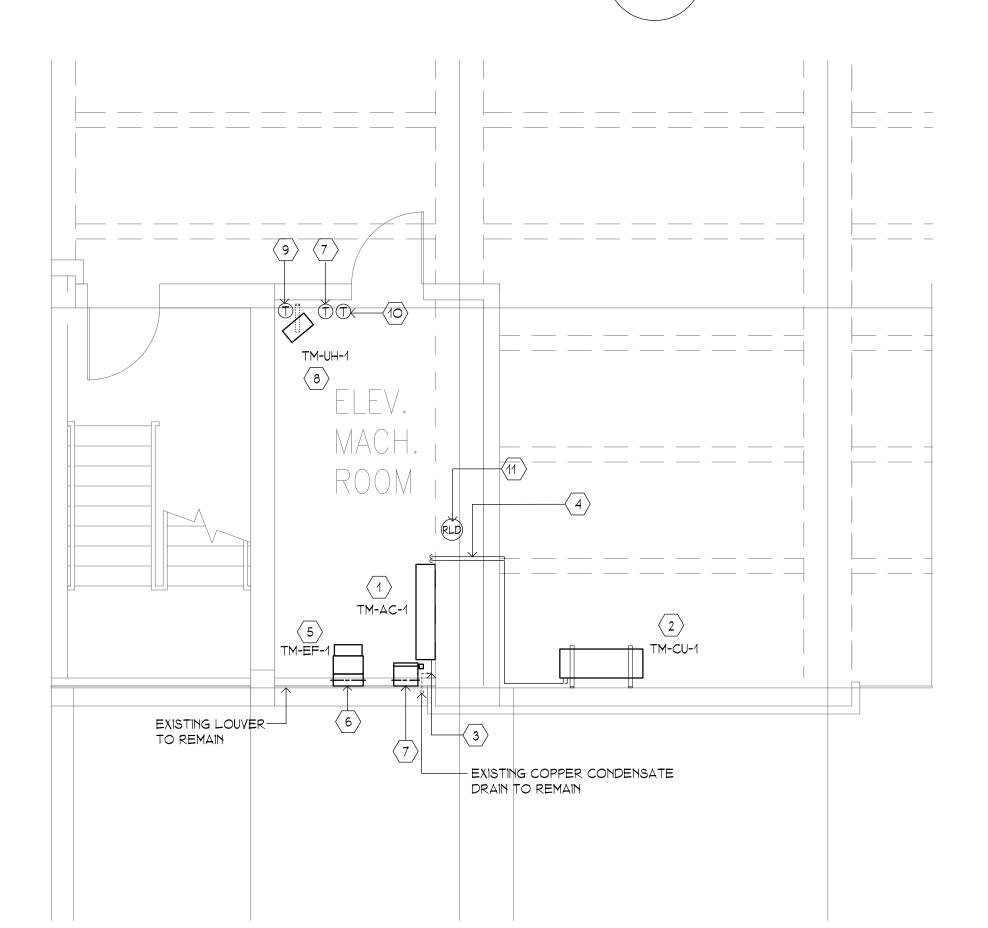	SCHE	EDULE F	OR DUCT	_ESS	S SPLI	T SYST	EM							(BASI	S OF DESI	GN: TRANE/ MITSUBI	SH1)	
		INDOOR UNIT				OUT	DOOR UNIT			COOLING PERFORM,	ANCE		ELEC	CTRICAL		REFRIGERATION	ERANT	
TAG	AREA SERVED	TYPE AND MODEL	W X H X D INCH	WEIGHT (LBS)	TAG	MODEL	W X H X D INCH	WEIGHT (LBS)	CAPACITY	(BTU/HR)	EER	SEER	V/PH/HZ	MCA AMP	RFS AMP	PIPING (IN) LIQUID / VAPOR	REFRIGE	NOTES
TM-AC-1	GROUND FLOOR EMR	WALL MOUNTED PKA-AK24NL	46.1 X 14.375 X 11.625	46	TM-CU-1	PUY-AK24NL	37.4 X 37.1 X 16.6	151	10,000	24,000	13.2	22.6	208-230/1/60	22	25	3/8 X 5/8	R454B	1 TO 5

NOTES

- 1 PROVIDE DISCONNECT SWITCH
- MANUFACTURER PROVIDED WALL MOUNTED WIRED CONTROLLER

3 PROVIDE LOW AMBIENT WIND BAFFLE FOR COOLING OPERATION DOWN TO -40 DEG F

PACKAGED

WALL FAN

0.125

1271

| 1725 | 12XPD-EC

4 INDOOR UNIT TO RECEIVE POWER FROM OUTDOOR UNIT THROUGH FIELD SUPPLIED INTERCONNECTING WIRING

115 V SHUTTER

1, 2, 3

5 SIDEWALL MOUNTED OUTDOOR UNIT PROVIDE WITH WALL BRACKET

EXH	IAUST FAN SCHI	EDULE		(BA	ASED ON LO	OREN COOK)						
	AREA			STATIC	FAN	ELECTRIC	CAL	MOTOR				
TAG	SERVED	TYPE	CFM	PRESS (IN. WG.)	RPM	VOLTS/	НР	ENCLOSURE	RPM	MODEL	DAMPER ACTUATOR VOLTAGE	NOTES

NOTES:

TM-EF-1 GROUND FLR EMR

- 1. DIRECT DRIVE PACKAGED WALL FAN, PROVIDE WITH: DISCONNECT SWITCH, EC MOTOR, MOTORIZED SHUTTER AND EXPANDED METAL SHUTTER GUARD WITH INSECT SCREEN
- 2. PROVIDE WITH TEMPERATURE CONTROLLER LOREN COOK MODEL VFTC AND VARIFLOW AIR BALANCE KIT (VFABK). PROVIDE VFABK WITH 24-YOLT TRANSFORMER. INTERLOCK WITH THE EXHAUST FAN AND THE OA MOTORIZED DAMPER. CONTRACTOR TO PROVIDE ALL REQUIRED DEVICES AND INTERLOCK WIRINGS.
- 3. INTERLOCK WITH CONTRACTOR PROVIDED REFRIGERANT LEAK DETECTOR. LEAK DETECTOR SHALL BE EQUIVALENT TO BACHARACH MGS-450 SERIES. COORDINATE EXACT

1530 | 115/1 | 1/4 | OPEN-EC

DEMOLITION LEGEND

SYMBOL	DESCRIPTION

%/////////////////////////////////////	EXISTING EQUIPMENT TO BE REMOVED
'H//////}	EXISTING PIPING OR
OR	EQUIPMENT TO BE
├	REMOVED

PLAN DEMOLITION NOTES

- EXISTING DUCTLESS SPLIT SYSTEM TO BE REPLACED. DISCONNECT AND REMOVE EXISTING DUCTLESS SPLIT SYSTEM. DISCONNECT AND REMOVE EXISTING REFRIGERATION PIPING AND PIPING INSULATION. RECOVER EXISTING REFRIGERANT IN THE SYSTEM PRIOR TO DISCONNECTION. DSIPOSE RECOVERED REFRIGERANT IN ACCORDANCE WITH THE EPA REQUIREMENTS.
- EXISTING CONDENSATE DRAIN TUBING FROM UNIT TO EXISTING COPPER CONDENSATE DRAIN PIPING TO BE
- REMOVED. EXISTING REFRIGERATION PIPING AND INSULATION TO
- EXISTING ELECTRIC UNIT HEATER TO BE REPLACED. (4) DISCONNECT AND REMOVE EXISTING ELECTRIC UNIT HEATER. EXISTING WALL BRACKET TO REMAIN
- EXISTING WALL MOUNTED THERMOSTAT TO BE

BE REMOVED AND REPLACED.

- 5 REPLACED.
- EXISTING WALL MOUNTED WIRELESS DUCTLESS SPLIT 6 SYSTEM CONTROLLER TO BE REMOVED
- 7 EXISTING WALL MOUNTED AIR CONDITIONER TO BE REMOVED. EXISTING OPENING TO BE REUSED
- EXISTING WALL MOUNTED AIR CONDITIONER TO BE REMOVED. EXISTING OPENING TO BE REUSED

CONSTRUCTION NOTES

- NUMBERED NOTES ARE APPLICABLE TO DRAWING SHEET ONLY
- DUCTLESS SPLIT WALL MOUNTED INDOOR UNIT. PROVIDE WITH WALL BRACKET. INSTALL IN ACCORDANCE WITH THE MANUFACTURER'S INSTALLATION AND CLEARANCE REQUIREMENTS.
- SIDEWALL MOUNTED CONDENSING UNIT. PROVIDE WITH MOUNTING BRACKET SUITED FOR THE NEW CONDENSING UNIT SIZE AND WEIGHT. COORDINATE HEIGHT OF MOUNTING BRACKET IN FIELD. INSTALL N ACCORDANCE WITH MANUFACTURER'S CLEARANCE REQUIREMENTS
- CONDENSATE DRAIN PIPING CONNECT TO EXISTING COPPER CONDENSATE $^{
 angle}$ drain. Contractor to provide the required pitch for gravity drain CONNECTION. COORDINATE IN FIELD.
- INSULATED LIQUID AND GAS REFRIGERATION PIPING FROM INDOOR UNIT TO OUTDOOR UNIT. PROVIDE FIRESTOP CAULKING AT RATED WALL PENETRATION. COORDINATE ROUTING IN FIELD.
- NEW PROPELLER EXHAUST FAN. PROVIDE WITH WALL HOUSING AND HOUSING EXTENSION. REUSE EXISTING OPENING AND BLANK-OFF REMAINDER OF UNUSED OPENING. INSTALL IN ACCORDANCE WITH MANUFACTURER'S REQUIREMENTS. PROVIDE ANGLE SUPPORT AS REQUIRED. PROVIDE WITH 115 V MOTORIZED SHUTTER INTERLOCKED WITH THE EXHAUST FAN. MOUNT SHUTTER IN COLLAR IN ACCORDANCE WITH THE MANUFACTURER'S CLEARANCE REQUIREMENTS. PROVIDE STATIC FIRE DAMPER, UL 555 CLASSIFIED, 1-1/2 HR RATING.INSTALL IN ACCORDANCE WITH MANUFACTURER'S REQUIREMENTS
- NEW 24X12 OA DUCTWORK FLUSHED TO THE TO THE FACE OF EXISTING LOUVER. SUPPORT AND SECURE DUCTWORK FROM INSIDE WALL. PROVIDE FIRE DAMPER WITH ACCESS DOOR AT OPENING. PROVIDE NEW MOTORIZED DAMPER AND ACTUATOR. BLANK-OFF REMAINING UNUSED OPENING. COORDINATE EXACT SIZE IN FIELD
- (7) WIRED WALL MOUNTED DUCTLESS SPLIT SYSTEM CONTROLLER. PROVIDE
- WITH INTERLOCK WIRING (8) ELECTRIC UNIT HEATER. PROVIDE WITH NEW WALL BRACKET. LOCATE UNIT HEATER TO CLEAR ELECTRICAL PANEL. COORDINATE IN FIELD
- \langle 9 \rangle WALL MOUNTED THERMOSTAT. INTERLOCK WITH ELECTRIC UNIT HEATER
- PROVIDE WITH TEMPERATURE CONTROLLER LOREN COOK MODEL VETC AND (10) VARIFLOW AIR BALANCE KIT (VFABK), OR EQUIVALENT. PROVIDE VFABK WITH 24-VOLT TRANSFORMER. CONTROLLER WILL BE INTERLOCKED WITH THE EXHAUST FAN AND THE OA MOTORIZED DAMPER. PROVIDE ALL REQUIRED DEVICES AND INTERLOCK WIRINGS.
- (11) WALL MOUNTED REFRIGERANT LEAK DETECTOR. MOUNT AT 9" AFF. INTERLOCK WITH EXHAUST FAN , OA AIR DAMPER AND ELECTRIC UNIT HEATER. REFER TO 23 O9 26 FOR SEQUENCE OF OPERATION

ELECTRIC UNIT HEATER SCHEDULE HEATING | ELECTRICAL DATA CONTROL LOCATION CFM CAPACITY MODEL VOLT VOLTS PHASE GROUND FLR EMR 650 7.5/10 TM-EUH-1 208/240

NOTES:

OF ELEMENTS

1. PROVIDE WITH FACTORY INSTALLED 24V CONTROL TRANSFORMER 2. PROVIDE WITH AUTOMATIC RESET LINEAR THERMAL CUT-OUT,

CAPILLARY TYPE TO PROVIDE PROTECTION OVER ENTIRE LENGTH

4. PROVIDE DISCONNECT SWITCH

3. PROVIDE WITH WALL MOUNTED

SYMBOL LEGEND (NOT ALL SYMBOLS ARE USED) REFERENCE, NUMBER INDICATES NOTE EXISTING PIPING OR EQUIPMENT EXISTING PIPING OR FLEXIBLE DUCT CONNECTION POINT OF CONNECTION \rightarrow TRANSITION ---MD MOTORIZED DAMPER FIRE DAMPER FIRE DAMPER WITH ACCESS DOOR FD/AD

ABBREVIATIONS (NOT ALL SYMBOLS ARE USED)

THERMOSTAT/SENSOR

PIPE ELBOW, TURNED DOWN

PIPE COUPLING

- AC- # INDOOR AIR CONDITIONING UNIT AD ACCESS DOOR
- AFF ABOVE FINISHED FLOOR CAP CAPACITY
- CFM CUBIC FEET PER MINUTE

(----

-

- CUH CABINET UNIT HEATER DB DRY BULB
- DD DIRECT DRIVE EF-# EXHAUST FAN
- EAT ENTERING AIR TEMPERATURE EER ENERGY EFFICIENCY RATIO

EMR ELEVATOR MACHINE ROOM EUH-# ELECTRIC UNIT HEATER

- EX EXISTING EXH EXHAUST
- DEGREES FAHRENHEIT FD FIRE DAMPER
- FLA FULL LOAD AMPERES
- FEET
- GENERAL CONTRACTOR GC
- HORSEPOWER HTG HEATING
- INCHES KILOWATT
- LEAVING AIR TEMPERATURE
- MBH 1000 BTU'S MCA MINIMUM CIRCUIT AMPACITY
- MD MOTORIZED DAMPER MFS MAXIMUM FUSE SIZE MINIMUM
- OUTSIDE AIR
- OAT OUTDOOR AIR TEMPERATURE PΗ PHASE
- RM ROOM
- RPM REVOLUTIONS PER MINUTE STATIC PRESSURE SQ FT SQUARE FOOT (AREA)
- ST SINGLE POLE SWITCH W/THERMAL OVERLOAD
- SIDE WALL REGISTER THERMOSTAT TEMPERATURE DIFFERENCE
- TEMP TEMPERATURE TOTAL
- TYPICAL WITH
- WET BULB WB WMS WIRE MESH SCREEN WT WEIGHT (LBS)

- GENERAL
- THE INTENT OF THESE CONTRACT DOCUMENTS IS FOR THE CONTRACTOR TO FURNISH AND INSTALL COMPLETE HVAC SYSTEMS. ALL SYSTEMS SHALL BE COMPLETE IN ALL RESPECTS. OPERATING, TESTED, ADJUSTED, APPROVED BY THE AUTHORITIES HAVING JURISDICTION AND READY FOR BENEFICIAL USE BY THE OWNER.
- THE CONTRACTOR SHALL OBTAIN AND REVIEW ALL CONTRACT DOCUMENTS, INCLUDING PROJECT MANUAL, PLANS AND SPECIFICATIONS OF ALL TRADES BEFORE SUBMITTING BID. REFER TO SPECIFICATIONS, PROJECT MANUAL AND PLANS, INCLUDING ALL EQUIPMENT SCHEDULES FOR
- MECHANICAL AND ELECTRICAL INFORMATION. CONTRACTOR SHALL WALK THROUGH BUILDING PRIOR TO SUBMITTING BID. 3. ALL OF THE CONTRACT DRAWINGS AND SPECIFICATIONS ARE COMPLEMENTARY TO FORM A TOTAL DESIGN PACKAGE. IT IS THE RESPONSIBILITY OF THE GENERAL

CONTRACTOR/CONSTRUCTION MANAGER TO DETERMINE WHICH TRADE CONTRACTOR IS RESPONSIBLE FOR VARIOUS

- PORTIONS OF THE WORK. 4. ALL WORK AND ACTION DEPICTED AND DESCRIBED IN CONTRACT DOCUMENTS SHALL BE PERFORMED BY THE CONTRACTOR UNLESS SPECIFICALLY NOTED OTHERWISE.
- 5. THE DRAWINGS ARE DIAGRAMMATIC AND INDICATE THE GENERAL ARRANGEMENT OF SYSTEMS AND WORK INCLUDED IN THE CONTRACT. THE CONTRACTOR SHALL COORDINATE LOCATIONS OF EQUIPMENT WITH ALL TRADES BEFORE STARTING CONSTRUCTION. ANY MODIFICATIONS TO THE EQUIPMENT LAYOUT REQUIRED FOR INSTALLATION ARE TO BE PERFORMED AT NO ADDITIONAL COST TO THE OWNER.
- . WHEN CONFLICTS OCCUR BETWEEN THE DRAWINGS AND/OR SPECIFICATIONS IT SHALL BE BROUGHT TO THE ATTENTION OF THE ENGINEER. THE CONTRACTOR SHALL CARRY AS PART OF THE BID THE LARGER QUANTITY AND/OR MORE EXPENSIVE ITEM(S). ALL WORK SHALL BE PERFORMED IN ACCORDANCE WITH

THE REQUIREMENTS OF THE CONTRACT GENERAL

CONDITIONS AND WITH THE PROVISIONS OF ALL APPLICABLE LOCAL, STATE, AND FEDERAL CODES AND LAWS. 8. ALL WORK AND ACTION DEPICTED AND DESCRIBED SHALL BE PERFORMED BY THE CONTRACTOR. ITEMS AND SERVICES NOT SHOWN ON DRAWINGS OR SPECIFICATIONS BUT ARE REQUIRED TO RENDER THE WORK COMPLETE AND READY

FOR OPERATION, SHALL BE PROVIDED WITHOUT ADDITIONAL

9. OBTAIN AND PAY FOR ALL REQUIRED PERMITS AND

INSPECTIONS.

FIRE DAMPER.

- 10. PROVIDE SUPPORT/BRACING OF EQUIPMENT AND BUILDING SERVICES AS REQUIRED BY THE BUILDING CODE.
- REPAIR AND REPLACE AT NO COST TO OWNER ALL EQUIPMENT AND MATERIALS DAMAGED DURING CONSTRUCTION.
- 12. ALL EQUIPMENT, MATERIALS AND RELATED SYSTEMS COMPONENTS SHALL BE NEW UNLESS SPECIFICALLY NOTED OTHERWISE. 13. ALL EQUIPMENT, PIPING, DUCTWORK SHALL BE SUPPORTED
- AS DETAILED, SPECIFIED AND REQUIRED TO PROVIDE A VIBRATION FREE INSTALLATION. 14. CONTRACTORS SHALL PROVIDE ALL REQUIRED SLEEVES
- AND SEALS FOR PIPES OR CONDUIT PENETRATING WALLS OR FLOOR SLABS WITH FIRE STOPPING SEALANT WHERE REQUIRED.
- PROVIDE VIBRATION ISOLATION FOR ALL MECHANICAL EQUIPMENT. 16. INSTALL COMPLETE OPERATING SYSTEMS. PROVIDE ALL
- COMPONENTS, DEVICES, CONTROLS, RELAYS, TRANSFORMERS, ETC., WHETHER INDICATED OR NOT, FOR COMPLETE SYSTEMS AS INTENDED BY THE CONSTRUCTION
- 17. ALL PENETRATIONS THRU RATED WALLS, FLOORS & CEILINGS SHALL BE SEALED USING U.L. LISTED METHODS APPROPRIATE FOR INDICATED RATING
- 18. PROVIDE ACCESS DOORS/PANELS FOR INSTALLATION IN WALLS AND/OR CEILINGS, WHERE REQUIRED, TO SERVICE
- 19. PROVIDE ACCESS DOORS/PANELS FOR INSTALLATION IN WALLS AND/OR CEILINGS, WHERE REQUIRED, TO SERVICE FIRE DAMPER.

ALTERATION WORK AND DEMOLITION

- 1. THE EXISTING CONDITIONS REPRESENTED HEREON ARE BASED ON GENERAL LOCATIONS OF EXISTING COMPONENTS IN THE FIELD AND ARE SHOWN ON THIS DRAWING FOR CONTRACTORS REFERENCE ONLY. ACTUAL LOCATION AND SIZE OF EQUIPMENT AND DUCTWORK AND EXTENT OF DUCTWORK ROUTING, PIPING AND EXTENT OF PIPING LENGTH AND ROUTING AND UTILITIES MAY VARY IN FIELD. MECHANICAL CONTRACTOR SHALL VERIFY LOCATIONS IN FIELD AND MAKE ALLOWANCE IN BID FOR LOCATIONS AND ARRANGEMENTS OTHER THAN SHOWN.
- THE DEMOLITION NOTES ARE FOR DESCRIPTIVE GUIDE ONLY. THE CONTRACTOR SHALL BE RESPONSIBLE FOR THE REMOVAL OF ALL ITEMS WHETHER OR NOT INDICATED AND/ OR NOTED ON THE DRAWINGS. INCLUSION OF THESE EXISTING CONDITIONS HEREON SHALL IN NO WAY ALLEVIATE THE CONTRACTOR(S) OF HIS RESPONSIBILITY TO VISIT THE SITE TO VERIFY ALL EXISTING CONDITIONS.
- REMOVE, MODIFY AND REPLACE EXISTING SYSTEMS AS REQUIRED FOR INSTALLATION OF NEW HYAC SYSTEMS.
- 4. IT IS NOT THE INTENT OF THESE DRAWINGS TO SHOW EVERY PIECE OF EQUIPMENT, PIPING OR CONDUIT TO BE REMOVED. EQUIPMENT NOT BEING USED SHALL BE REMOVED INCLUDING ALL ASSOCIATED HANGERS, SUPPORTS, PIPES, DUCTS, CONDUITS, WIRES AND CONTROLS BACK TO THE POINT OF
- 5. ALL WASTE MATERIALS AND EQUIPMENT SHALL BE REMOVED FROM SITE AND SHALL BE LEGALLY DISPOSED BY THE CONTRACTOR.
- NO EQUIPMENT, PIPING OR CONDUIT SHALL BE ABANDONED IN PLACE UNLESS SPECIFICALLY NOTED.
- 7 NO WORK SHALL BE LEFT INCOMPLETE NOR ANY HAZARDOUS SITUATIONS CREATED WHICH WILL AFFECT THE LIFE OR SAFETY OF THE PUBLIC AND/OR BUILDING OCCUPANTS. AT NO TIME SHALL THE WORK INTERFERE WITH OR CUTOFF ANY OF THE EXISTING SERVICES WITHOUT THE OWNER'S WRITTEN PERMISSION.
- 8. COORDINATE SHUTDOWN OF EXISTING SERVICES WITH OWNER'S MAINTENANCE PERSONNEL. NO WORK SHALL TAKE PLACE UNTIL DOING SO.
- 9. THE CONTRACTOR IS RESPONSIBLE FOR COORDINATING HIS WORK WITH ALL TRADES.
- 10. PIPING AND DUCT WORK LAYOUTS AS INDICATED ON THE DRAWINGS ARE DIAGRAMATIC; PROVIDE ADDITIONAL TRANSITIONS AND OFFSETS AS REQUIRED FOR COORDINATION WITH BUILDING CONSTRUCTION AND THE WORK OF OTHER TRADES.
- 11. PROVIDE FIRE DAMPERS AT DUCT PENETRATIONS OF FIRE RATED PARTITIONS.
- 12. MAINTAIN MANUFACTURER'S RECOMMENDED MINIMUM
- CLEARANCES FOR INSTALLATION OF EQUIPMENT. 13 INSTALL COMPLETE OPERATING SYSTEMS. PROVIDE ALL COMPONENTS, DEVICES, CONTROLS, RELAYS,
- DOCUMENTS. 14 THE TEMPERATURE CONTROL SYSTEM SHALL BE COMPLETE IN ALL REGARDS, TESTED AND CAPABLE OF ACHIEVING THE SEQUENCES OF OPERATION. ALL DEVICES SHALL BE UNDER SYSTEM CONTROL. ALL SPACES SHALL BE THERMOSTATICALLY CONTROLLED WHETHER OR NOT A

TRANSFORMERS, ETC., WHETHER INDICATED OR NOT, FOR COMPLETE SYSTEMS AS INTENDED BY THE CONSTRUCTION

THERMOSTAT, SENSOR OR CONTROLLER IS INDICATED.

H

REVISIONS DRAWING TITLE TEMPLE MEDICAL

NO. DATE BY

GROUND FLOOR EMR

PLANS DRAWING NO.

TM-M-1SCALE: AS NOTED

DATE: JULY 2025 PROJECT NO. 20-20176.00-2 NHPA NO. 21-011 DESIGN DRAWN CH'KD. AMG AMG RRB

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ELEVATOR - # 1 & 2 GROUND LEVEL ELECTRICAL DEMOLITION

SCALE: 1/4" = 1'-0"

TYPICAL OF 6
LANDINGS

ER

S
REC

SERW
ERW
ERW
ERW
ERW


ELEVATOR - # 3 & 4 GROUND LEVEL ELECTRICAL DEMOLITION


SCALE: 1/4" = 1'-0"

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PENTHOUSE ELEVATOR MACHINE ROOM # 1 & 2 ELECTRICAL DEMOLITION LEVEL - 10


SCALE: 1/4" = 1'-0"



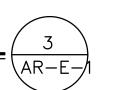

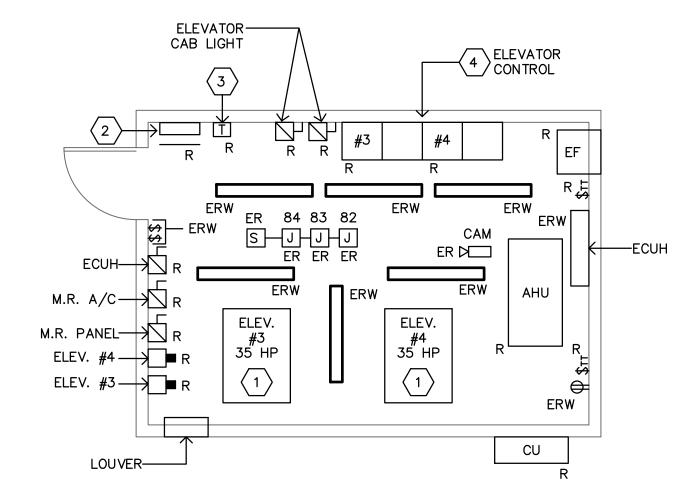PENTHOUSE ELEVATOR MACHINE ROOM # 3 & 4 ELECTRICAL DEMOLITION — LEVEL 9

SCALE: 1/4" = 1'-0"

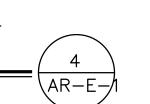

<u>ELEVATORS "A"</u> -TYPICAL AREA OF WORK FOR GROUND THRU 6TH FLOOR

DEMOLITION KEY NOTES

- APPROXIMATE LOCATION OF EXISTING ELEVATOR MOTOR TO BE DISCONNECTED BY ELECTRICAL CONTRACTOR. REMOVE ASSOCIATED WIRING AND CONDUIT BACK TO SOURCE.
- 2 APPROXIMATE LOCATION OF EXISTING ELECTRICAL PANEL (I-T-E) RATED FOR 30A, 240/120V 1 PHASE, 3 WIRE, FED FROM WIREWAY TO BE REPLACED.
- APPROXIMATE LOCATION OF EXISTING STEP-DOWN TRANSFORMER RATED FOR 5KVA, 480V-240/120V 1 PHASE, 3 WIRE, FED FROM WIREWAY TO BE REPLACED.
- APPROXIMATE LOCATION OF EXISTING ELEVATOR CONTROLLER TO BE DISCONNECTED BY ELECTRICAL CONTRACTOR. DISCONNECT ALL ELECTRICAL COMPONENTS AND ASSOCIATED WIRING AND CONDUIT BACK TO SOURCE.


DEMOLITION ABBREVIATION

- ER EXISTING TO REMAIN (UNLESS OTHERWISE INDICATED, SHOWN FOR REFERENCE PURPOSE ONLY).
- ERW EXISTING UNIT/DEVICE TO BE REPLACED AT SAME LOCATION. CONTRACTOR TO RETAIN ASSOCIATED WIRING AND CONDUIT TO SUIT NEW. REFER TO NEW WORK FOR ADDITIONAL INFORMATION.
- R EXISTING TO BE REMOVED. CONTRACTOR TO REMOVE ASSOCIATED DEVICES, WIRING AND CONDUIT BACK TO
- RR EXISTING TO BE REMOVED AND RELOCATED. CONTRACTOR TO EXTEND ASSOCIATED WIRING AND CONDUIT TO NEW LOCATION.

DEMOLITION GENERAL NOTES


- UNLESS OTHERWISE INDICATED, THE ELECTRICAL CONTRACTOR SHALL REMOVE ALL INDICATED ELECTRICAL EQUIPMENT, ACCESSORIES, CONTROLS, DEVICES, AND ASSOCIATED CONDUIT AND WIRING BACK TO SOURCE OR LAST DEVICE.
- 2. NO EQUIPMENT OR DEVICES THAT HAVE BEEN DISCONNECTED AND/OR ABANDONED SHALL REMAIN.
- 3. THE ELECTRICAL CONTRACTOR SHALL VISIT THE SITE AND BECOME FAMILIAR WITH THE EXISTING SYSTEMS AND CONDITIONS IN AREAS OF RENOVATION.
- 4. ANY SYSTEMS OR EQUIPMENT TO REMAIN ACTIVE DURING RENOVATION SHALL BE KEPT IN OPERATION BY PROVIDING TEMPORARY CONNECTIONS AS REQUIRED UNTIL NEW SYSTEMS ARE INSTALLED AND OPERATIONAL.
- THE ELECTRICAL CONTRACTOR SHALL COORDINATE WITH THE OWNER, CM, AND/OR GENERAL CONTRACTOR ANY AND ALL PHASING OF THE MECHANICAL DEMOLITION WORK IN ORDER TO SATISFY THE CONSTRUCTION SCHEDULE AND OWNER'S OCCUPANCY REQUIREMENTS.
- 6. ANY ELECTRICAL EQUIPMENT TO BE REMOVED AND REUSED OR TURNED OVER TO THE OWNER, AT OWNERS REQUEST, OR AS INDICATED ON THE DRAWINGS SHALL BE CAREFULLY REMOVED AND STORED TO PREVENT DAMAGE.
- 7. THE ELECTRICAL CONTRACTOR SHALL ALSO REVIEW THE ARCHITECTURAL DEMOLITION DRAWINGS AS PART OF THIS CONTRACT FOR ADDITIONAL INFORMATION AND REQUIREMENTS.
- 8. ALL SERVICE INTERRUPTIONS SHALL BE COORDINATED AND APPROVED WITH THE OWNER IN ADVANCE PRIOR TO COMMENCEMENT OF ANY WORK.
- 9. THE ELECTRICAL CONTRACTOR SHALL COORDINATE HIS DEMOLITION WORK WITH THAT OF OTHER TRADES IN ORDER TO AVOID CONFLICTS.
- 10. ELECTRICAL COMPONENTS SHOWN ON THE DEMOLITION DRAWINGS, AND THE ASSOCIATED CONDUIT, WIRE & BOXES ARE TO BE REMOVED AND DISPOSED OF UNLESS SPECIFICALLY NOTED OTHERWISE.
- 11. ALL MATERIALS BEING REMOVED SHALL BE HANDLED IN A MANNER COMPLYING WITH ALL PERTINENT LAWS, CODES AND ENVIRONMENTAL REGULATIONS.
- 12. ALL REMOVED COMPONENTS SHALL BE LEGALLY DISPOSED OF BY CONTRACTOR UNLESS SPECIFICALLY NOTED OTHERWISE.
- 13. WHERE EXISTING DEVICES ARE REMOVED & NO NEW DEVICES ARE INSTALLED IN THE SAME LOCATION, REMOVE ALL WIRING FROM BOX & PROVIDE PROPERLY SIZED BLANK COVER PLATE.
- 14. WHERE ELECTRICAL EQUIPMENT & DEVICES ARE BEING REMOVED, COORDINATE AND FIELD VERIFY IF BRANCH CIRCUIT FEEDS THROUGH TO EQUIPMENT/DEVICES TO REMAIN. BRANCH CIRCUITS SHALL BE SPLICED OR RELOCATED TO MAINTAIN CONTINUATION OF SERVICES.

ELEVATORS "G" TYPICAL AREA OF WORK FOR GROUND THRU 6TH FLOOR

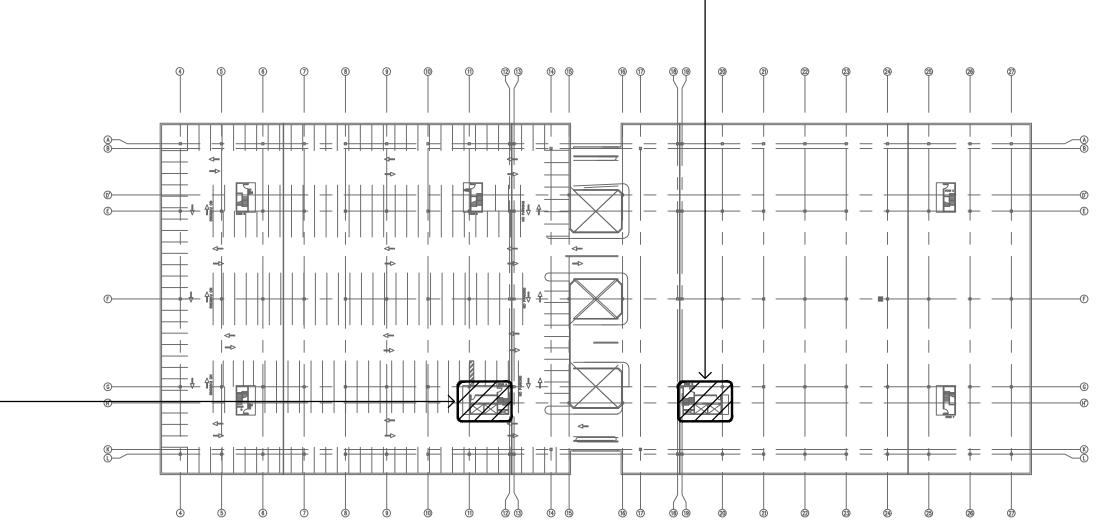

OVERALL KEY PLAN

NOT TO SCALE

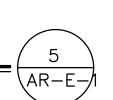

Design Manageme

SILVER / PETRUCELLI + ASSOCIATES

Architects and Engineers
3190 Whitney Avenue, Hamden, CT 06518-2340
Tel. 203 230 9007 Fax. 203 230 8247

S

AT THE NEW HAVEN PARKING AUTHORITY FACILITIES

NO. DATE BY
REVISIONS

DRAWING TITLE

AIR RIGHT—
ELECTRICAL
DEMOLITION
PART PLANS

DRAWING NO.


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SCALE: AS NOTED

DATE: JULY 2025
PROJECT NO. 20-20176.00-2
NHPA NO. 21-011
DESIGN DRAWN CH'KD.
J.R.P. R.R.B.


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ELEVATOR - # 1 & 2 GROUND LEVEL ELECTRICAL NEW WORK SCALE: 1/4" = 1'-0"




PENTHOUSE ELEVATOR MACHINE ROOM # 1 & 2 ELECTRICAL POWER NEW WORK - LEVEL 10

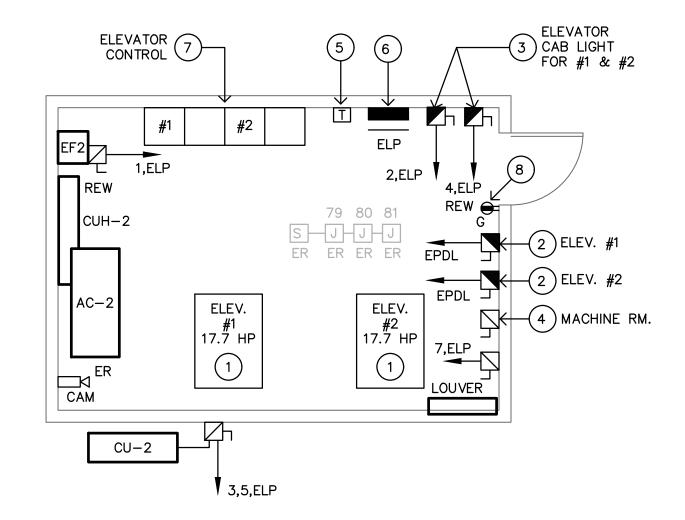
SCALE: 1/4" = 1'-0"

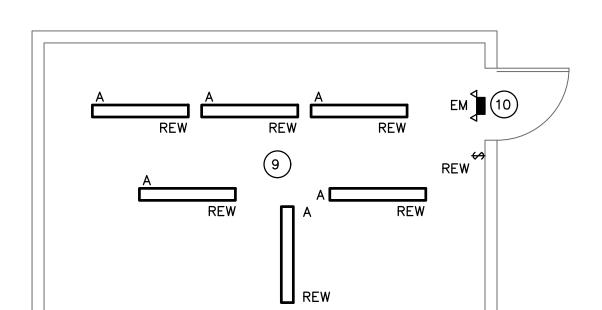


PENTHOUSE ELEVATOR MACHINE ROOM # 1 & 2 ELECTRICAL LIGHTING NEW WORK

SCALE: 1/4" = 1'-0"

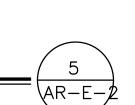

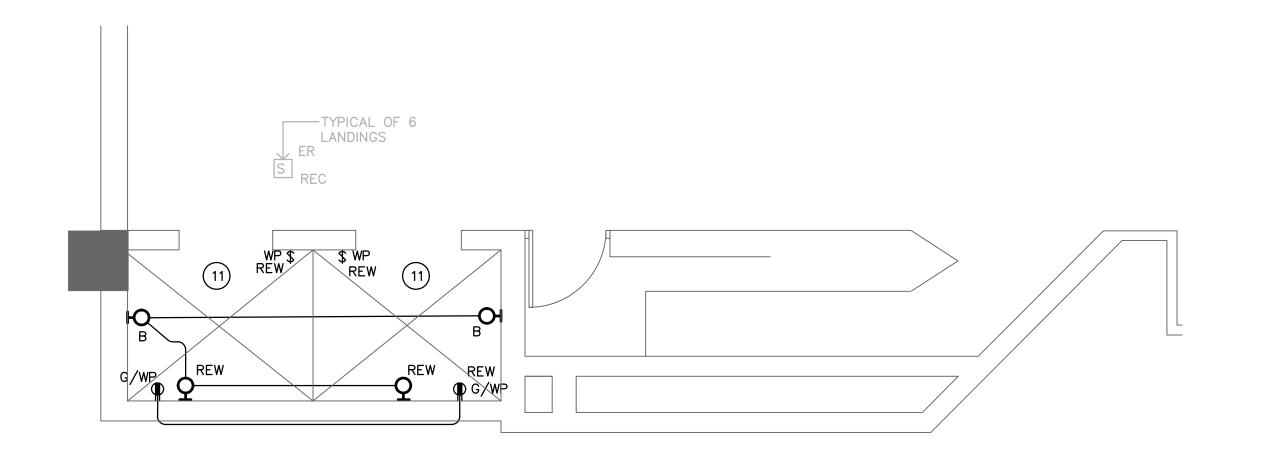


ELEVATOR - # 3 & 4 GROUND LEVEL ELECTRICAL NEW WORK SCALE: 1/4" = 1'-0"

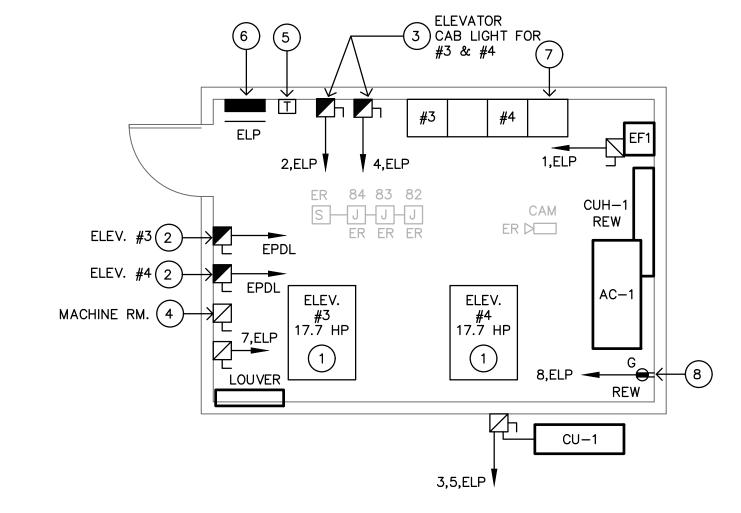


PENTHOUSE ELEVATOR MACHINE ROOM # 3 & 4 ELECTRICAL POWER NEW WORK LEVEL 9

SCALE: 1/4" = 1'-0"

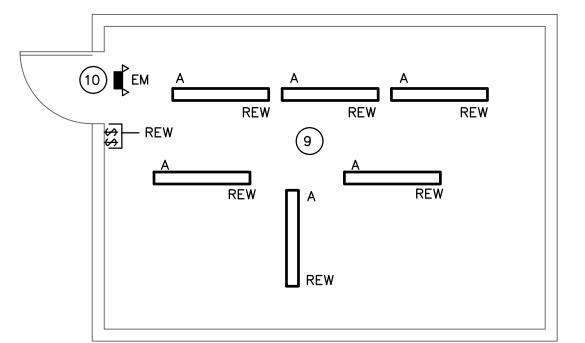

PENTHOUSE ELEVATOR MACHINE ROOM # 3 & 4 ELECTRICAL LIGHTING NEW WORK

SCALE: 1/4" = 1'-0"

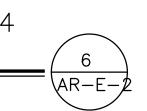

ELEVATORS 1 & 2 -TYPICAL AREA OF WORK FOR GROUND THRU 6TH FLOOR

APPROXIMATE LOCATION OF MAIN-ELECTRICAL ROOM IN HIGHWAY LEVEL

NEW WORK KEY NOTES

- NEW ELEVATOR AC GEARLESS MACHINE WITH MOTOR TO BE PROVIDED BY ELEVATOR INSTALLER. CONTRACTOR TO WIRE MOTOR RATED FOR 17.7 HP TO CORRESPONDING ELEVATOR DISCONNECT.
- PROPOSED LOCATION FOR FUSED DISCONNECT SWITCH RATED FOR 60AMP-3P WITH 40AMP FUSE, 480V-3PHASE TO SUIT CORRESPONDING ELEVATOR . DISCONNECT SHALL BE LOCKABLE IN THE OPEN POSITION. PROVIDE AUXILIARY CONTACT WITHIN DISCONNECT TO BE INTERCONNECTED WITH ELEVATOR CONTROLLERS. INTERCONNECT DISCONNECT WITH ELEVATOR MOTOR AND ELECTRICAL PANEL "EPDL" LOCATED IN MAIN ELECTRICAL ROOM IN HIGHWAY LEVEL. PROVIDE ALL COMPONENTS NECESSARY FOR A COMPLETE MANUFACTURER/ENGINEER APPROVED INSTALLATION TO BE FULLY OPERATIONAL.
- PROPOSED LOCATION FOR FUSED DISCONNECT SWITCH RATED FOR 30A, 120V-1 PHASE TO SUIT CAB LIGHTING AND VENTILATION. DISCONNECT SHALL BE LOCKABLE IN THE OPEN POSITION. INTERCONNECT WITH CAB LIGHTING, VENTILATION AND NEW ELECTRICAL PANEL "ELP". PROVIDE 20A-1P CIRCUIT BREAKER, 3/4"C, 3#12 AND ALL COMPONENTS NECESSARY FOR A COMPLETE MANUFACTURER/ENGINEER APPROVED INSTALLATION TO BE FULLY OPERATIONAL.
- PROPOSED LOCATION FOR NEW DISCONNECT SWITCH RATED FOR 30A, 480V TO SERVE NEW STEP-DOWN TRANSFORMER. CONTRACTOR TO FEED UNIT FROM EXISTING POWER SOURCE/ELECTRICAL PANEL AND PROVIDE 25A-3P, 3/4"C, 3#10, 1#10G.
- PROPOSED LOCATION FOR NEW WALL MOUNT STEP-DOWN TRANSFORMER RATED FOR 15KVA, 480-120/240-1PH. MOUNT AND WIRE AS PER MANUFACTURER REQUIREMENTS.
- PROPOSED LOCATION FOR NEW ELECTRICAL PANEL ELP RATED FOR 60A, 120/240V-1PH. REFER TO PANELBOARD SCHEDULE AND ONE-LINE RISER DIAGRAM FOR ADDITIONAL INFORMATION.
- NEW ELEVATOR CONTROLLER TO BE PROVIDED AND INSTALLED BY ELEVATOR INSTALLER CONTRACTOR TO INTERCONNECT UNIT WITH CORRESPONDING ELEVATOR DISCONNECT AND PROVIDE ASSOCIATED WIRING AND CONDUIT.
- CONNECT/EXTEND POWER RECEPTACLE CIRCUIT TO NEW ELECTRICAL PANEL ELP AND PROVIDE 20A-1P BREAKER IN PANEL. PROVIDE NEW BRANCH CIRCUIT IF EXISTING IS NOT DEDICATED TO POWER RECEPTACLES.
- CONNECT/EXTEND LIGHTING CIRCUIT TO NEW ELECTRICAL PANEL ELP AND PROVIDE 20A-1P BREAKER IN PANEL. PROVIDE NEW BRANCH CIRCUIT IF EXISTING IS NOT DEDICATED TO LIGHTING.
- CONNECT TO ROOM LIGHTING CIRCUIT AHEAD OF SWITCHING DEVICE.
- PROVIDE NEW BRANCH CIRCUIT IF EXISTING IS NOT DEDICATED FOR POWER RECEPTACLES AND LIGHTING. PROVIDE (2) 20A-1P, 3/4"C, 2#12, 1#12G FROM PANEL ELP IN MACHINE ROOM.

NEW WORK ABBREVIATION


ER EXISTING TO REMAIN (UNLESS OTHERWISE INDICATED, SHOWN FOR REFERENCE PURPOSE ONLY). REW REPLACED EXISTING UNIT/DEVICE AT SAME LOCATION. RECONNECT TO EXISTING WIRING AND CONDUIT AND CONNECT/EXTEND TO NEW ELECTRICAL PANEL.

DRAWING GENERAL NOTES

- ONLY LINE VOLTAGE WIRING RATED FOR 120V SERVING ELEVATOR DEVICES CAN BE INSTALLED WITHIN ELEVATOR
- ELECTRICAL CONTRACTOR ASSUMES ALL RESPONSIBILITY DURING CONSTRUCTION TO PROTECT MATERIALS AND EQUIPMENT. ANY & ALL DAMAGED ITEMS & EQUIPMENT DURING CONSTRUCTION SHALL BE REPLACED AT NO
- ALL PANEL DIRECTORIES AFFECTED BY RENOVATION SHALL BE UPDATED WITH NEW CIRCUIT BREAKER DESIGNATION . ALL CIRCUIT BREAKERS SERVING ELEVATOR SHALL BE PROVIDED WITH LOCK TAB. DESIGN WAS DEVELOPED BASED ON THE BEST AVAILABLE INFORMATION PROVIDED IN ELECTRICAL PANELBOARD DIRECTORY. CONDUITS AND FEEDERS COULD NOT BE TRACED. CONTRACTOR MUST TRACE ELEVATOR FEEDERS AND

RATINGS: 60A MCB 22,000 AI SERVICE: 120/240V		′4 WIR	ŀΕ	PANEL ELP (typ. of 2)											LOCATION: MACHINE ROOM MOUNTING: SURFACE				
DESCRIPTION	NOTE	AMPS	TRIP AMP	POLE	CKT. TYP	CKT. NO.	A	В	CKT.	CKT. TYP	POLE	TRIP AMP	AMPS	NOTE	DESCRIPTION				
EF-1 & 2		6	20	1	Α	1	+	+	2	Α	1	20	2		CAR 1 LIGHT				
OU /AO 1 0 0		25	35	2	В	3	+	+	4	Α	1	20	2		CAR 2 LIGHT				
CU/AC 1 & 2		25	33	_	Ь	5	+	+	6	Α	1	20	2.5		E.M.R. LIGHTING				
INTAKE LOUVER		2	20	1	Α	7	+	+	8	Α	1	20	1.5		E.M.R. RECEPTACLE				
SPARE		0	20	1	1	9	+		10	_	1	20	0		SPARE				
SPARE		0	20	1	ı	11	+	+	12	_	1	20	0		SPARE				
SPARE		0	20	1	1	13	+		14	_	1	20	0		SPARE				
SPARE		0	20	1	1	15	\exists	+	16	_	1	20	0		SPARE				
SPACE		0	_	1	1	17	1		18	_	1	_	0		SPACE				
SPACE		0	-	1	1	19	\pm	+	20	_	1	_	0		SPACE				
SPACE		0	-	1	1	21	+		22	_	1	_	0		SPACE				
SPACE		0	_	1		23	Ŧ	+	24	_	1	_	0		SPACE				

- (1) PROVIDE CB LOCK.
- UPGRADE WIRE SIZE AS REQUIRED TO MAINTAIN 3% MAXIMUM VOLTAGE DROP.
- 3. TOTAL CONNECTED LOAD: PHASE A -35 6.6 KVA BASED ON 32 AMPS/PHASE PHASE B -35
- 4. CIRCUIT TYPE A: 120V, 3 WIRE IN CONDUIT OR MC CABLE. 5. CIRCUIT TYPE B: 240V, 1ø, 4 WIRE IN CONDUIT OR MC CABLE.

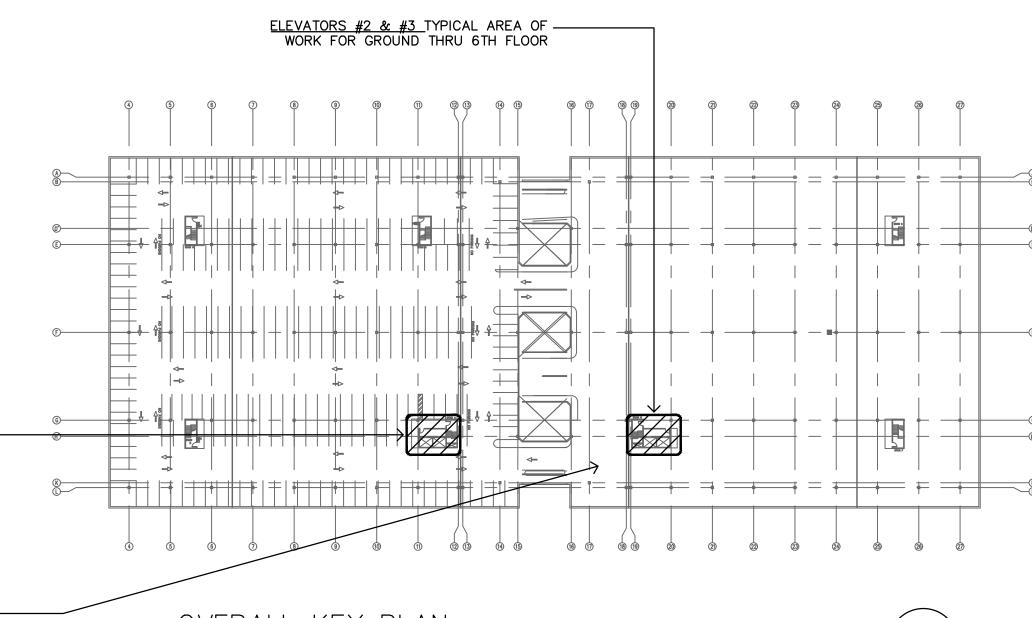

OVERALL KEY PLAN

NOT TO SCALE

J.R.P. J.R.P. R.R.B.

AT THE SING AUTHORITY

ELE

NO. DATE BY **REVISIONS** DRAWING TITLE AIR RIGHT -**ELECTRICAL**

NEW WORK PART PLANS DRAWING NO.

AR-E-2

SCALE: AS NOTED DATE: JULY 2025 PROJECT NO. 20-20176.00-2 NHPA NO. 21-011 DESIGN DRAWN CH'KD.

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NO.	DATE	BY
F	REVISIONS	
	GHT — RICAL LI AND G	•

DRAWING NO. AR-E-3

SCALE: AS NOTED DATE: JULY 2025 PROJECT NO. 20-20176.00-2 NHPA NO. 21-011 DESIGN DRAWN CH'KD.

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ELECTRICAL LEGEND EXISTING PANELBOARD SURFACE MOUNTED RATED FOR 120/208V-3PH.

ENCLOSED CIRCUIT BREAKER.

FUSED DISCONNECT SWITCH.

NON-FUSED DISCONNECT SWITCH.

→ DUPLEX RECEPTACLE. DUPLEX GROUND FAULT RECEPTACLE MOUNT 48" A.F.F.

WALL MOUNTED LIGHT FIXTURE.

LINEAR WALL MOUNTED LIGHT FIXTURE \$ SINGLE-POLE SWITCH; MOUNT AT 48" AFF.

\$3 SINGLE POLE THREE WAY SWITCH; MOUNT AT 48" AFF.

SINGLE-POLE PILOT SWITCH; MOUNT AT 48" AFF.

CAM □□□ SECURITY CAMERA.

FIRE ALARM ADDRESSABLE RELAY

FIRE ALARM SHUNT TRIP HEAT DETECTOR.

REC FIRE ALARM RECALL SMOKE DETECTOR.

WALL MOUNTED FIRE ALARM HEAT DETECTOR

— — CONDUIT AND WIRE, SWITCHED BRANCH CIRCUIT HOMERUN.

—— CONDUIT AND WIRE

ABBREVIATION

CONDUIT

CONDUIT

FIRE OR SMOKE RATED

UL LISTED FIRE SEALANT REFER TO PROJECT MANUAL

-SCHEDULE 40 GALVANIZED

-UL LISTED FIRE SEALANT

---FIRE OR SMOKE RATED

WALL/FLOOR

CONCRETE/MASONRY

REFER TO PROJECT MANUAL

`\AR−E−

PIPE SLEEVE


DRYWALL PARTITION

—FIRESTOP SEALANT

GROUND FAULT INTERRUPTER

PIPE SLEEVE

WP WEATHERPROOF

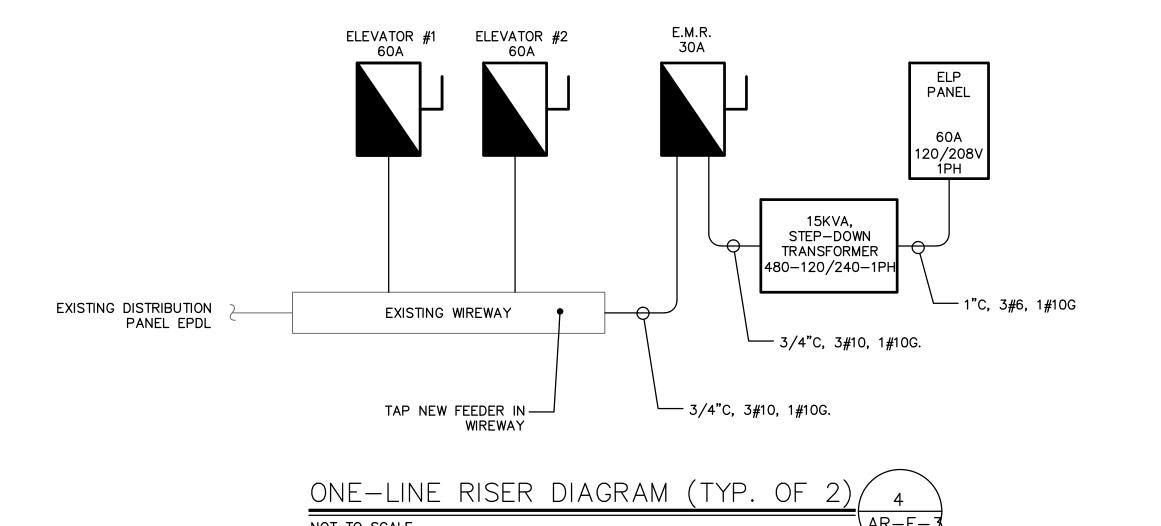

LIGHTING FIXTURE SCHEDULE

NOTES

MANUFACTURER/

MODEL NUMBER

FSI455L840-UNV

DWAE27L840-2-UNV-MD360W

DAY-BRITE

DAY-BRITE

CLU2NW

LAMP

COLOR

TEMP

LED 4000K

LED 4000K

LED N/A

ELECTRICAL

VOLTAGE

UNIVERSAL

UNIVERSAL


UNIVERSAL

ELECTRONIC

ELECTRONIC

ELECTRONIC

NOTES

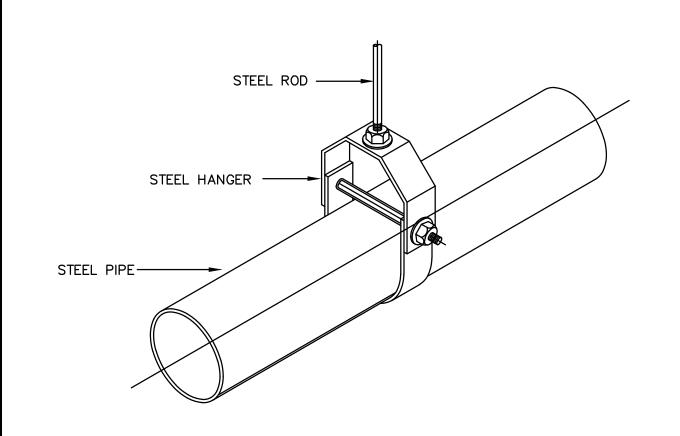

DESIGNATION

DESCRIPTION

2' LENGTH SURFACE MOUNT VAPORTIGHT LED WITH

(1) FURNISH WITH ALL REQUIRED MOUNTING HARDWARE AND CONNECTING CABLE.


(2) ALL FIXTURES SHALL BE CAPABLE OF OPERATING IN COLD TEMP (0° F).

4' LENGTH SURFACE MOUNT LINEAR LED WITH


DAMAGE RESISTANCE ACRYLIC LENS

TWIN HEAD EMERGENCY WALL PACK

FROSTED ACRYLIC LENS

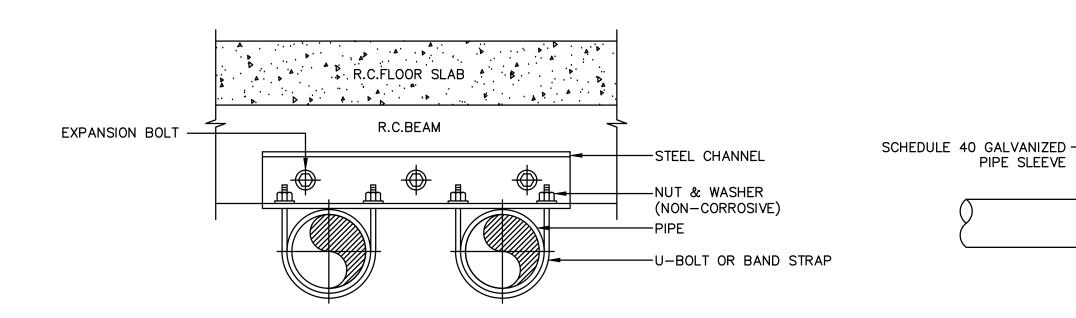

END VIEW

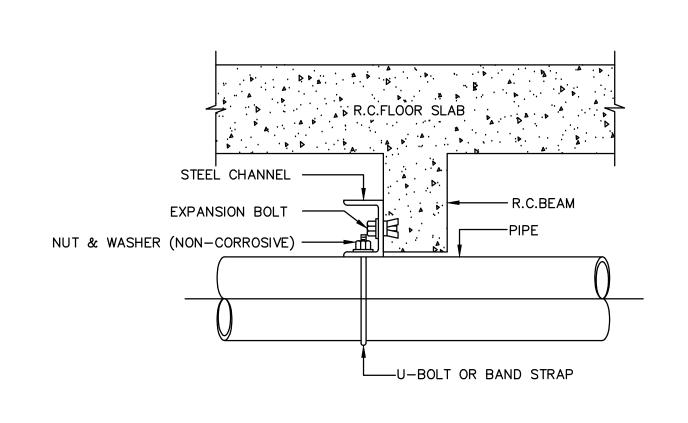

ELEVATION





NOT TO SCALE **GENERAL NOTES:**

GROUT SLEEVE IN -

MASONRY WALL

1. PROVIDE UL LISTED FIRE/SMOKE PENETRATION ASSEMBLY IN ACCORDANCE W/UL1479, ASTM E 814 REQUIREMENTS FOR WALL TYPE, RATING, PIPE SIZE

2. FIRESTOPPING SHALL HAVE A RATING EQUAL TO OR GREATER THAN THE WALL/FLOOR BEING PENETRATED - SEE PROJECT MANUAL. REFER TO DRAWINGS FOR WALL/FLOOR RATINGS AND LOCATIONS.

THE ELECTRICAL CONTRACTOR SHALL BE RESPONSIBLE FOR ALL WORK REQUIRED FOR A COMPLETE, FULLY OPERABLE INSTALLATION. ALL WORK TO BE DONE IN ACCORDANCE WITH THE LATEST APPROVED ISSUE OF THE NEC AND APPLICABLE

GENERAL NOTES

THIS IS AN EXISTING BUILDING. THE ELECTRICAL CONTRACTOR SHALL VISIT THE SITE PRIOR TO SUBMITTING A BID TO ASCERTAIN FIELD CONDITIONS AS THEY EXIST AND JUDGE THEIR EFFECT ON THE WORK TO BE DONE. NO ALLOWANCE WILL BE MADE FOR FAILURE TO VISIT THE JOB SITE AND MAKE THIS DETERMINATION.

THE DRAWINGS SHOW THE GENERAL LAYOUT AND SOME OF THE DETAIL, BUT THEY DO NOT SHOW EVERY FITTING, BEND, ETC. ELECTRICAL CONTRACTOR SHALL PROVIDE ALL SUCH MATERIALS TO MAKE A COMPLETE INSTALLATION.

4. DO NOT SCALE DRAWINGS: ACTUAL FIELD MEASUREMENTS AND DIMENSIONS TAKE PRECEDENCE IN ALL CASES.

. ALL WORK SHALL BE DONE IN ACCORDANCE WITH THE STANDARD GENERAL CONDITIONS OF THE CONSTRUCTION CONTRACT, AIA DOCUMENT 201, LATEST EDITION.

ELECTRICAL CONTRACTOR SHALL INSTALL ALL EQUIPMENT IN ACCORDANCE WITH MANUFACTURERS INSTRUCTIONS AND/OR REQUIREMENTS FOR PROPER OPERATION AND MAINTENANCE.

ELECTRICAL CONTRACTOR SHALL GIVE OWNER SEVEN (7) DAYS ADVANCE NOTICE OF SHUTDOWNS. SHUTDOWNS TO BE KEPT TO A MINIMUM. AT NO TIME SHALL THE BUILDING/SPACE BE LEFT WITHOUT COMMERCIAL POWER IN FULL OPERATING ORDER.

B. ELECTRICAL CONTRACTOR SHALL BE RESPONSIBLE FOR TESTING OF ALL PHASES OF THE WORK AND TO DEMONSTRATE TO

9. ELECTRICAL CONTRACTOR SHALL RESTORE ALL AREAS DISTURBED TO THEIR ORIGINAL CONDITION. ELECTRICAL CONTRACTOR IS RESPONSIBLE FOR ALL CUTTING, PATCHING, PAINTING, CLEAN-UP, ELECTRICAL DEBRIS REMOVAL AND GENERAL COORDINATION OF THE WORK EFFORT AS REQUIRED FOR THE INSTALLATION OF THE ELECTRICAL ITEMS OF WORK.

10. THE TERM "PROVIDE" SHALL MEAN TO FURNISH AND INSTALL IN COMPLETE WORKING ORDER.

11. THE SCOPE OF WORK IS AS SHOWN ON THE PLANS AND DETAILED IN THE SPECIFICATIONS

12. ALL THE WIRE SIZES ARE BASED ON COPPER; ALUMINUM IS NOT TO BE USED.

OWNER THAT THE EQUIPMENT IS IN FULL OPERATING ORDER.

13. ALL WIRING METHODS ARE TO BE IN ACCORDANCE WITH THE CURRENT ISSUE OF THE NATIONAL ELECTRICAL CODE. AND APPLICABLE LOCAL CODES. ALL WIRING IS TO BE IN CONDUIT, UNLESS SPECIFICALLY NOTED OTHERWISE. ALL WIRING IS TO BE CONCEALED.

14. PROVIDE INDEPENDENT SEISMIC SUPPORT OF ALL ELECTRICAL EQUIPMENT PER INTERNATIONAL BUILDING CODE.

15. ELECTRICAL CONTRACTOR SHALL SECURE ALL PERMITS AND PAY FOR ALL REQUIRED FEES.

16. ELECTRICAL CONTRACTOR SHALL WARRANT AND GUARANTEE ALL MATERIALS AND WORKMANSHIP FOR A PERIOD OF ONE (1) YEAR FROM THE DATE OF FINAL ACCEPTANCE BY THE OWNER.

17. ELECTRICAL CONTRACTOR SHALL PROVIDE PROOF OF LIABILITY AND PROPERTY INSURANCE TO THE OWNER. ALL DEDUCTIBLES SHALL BE PAID FOR BY THE ELECTRICAL CONTRACTOR IN THE EVENT OF A CLAIM.

18. PERSONNEL SAFETY IS OF PRIME IMPORTANCE. NO HAZARDOUS CONDITION MUST BE ALLOWED. EVERY CARE MUST BE TAKEN TO PROTECT CONSTRUCTION AND OTHER PERSONNEL. CLEANUP IS TO BE DONE ON A DAILY BASIS. ELECTRICAL CONTRACTOR

TO REMOVE AND DISPOSE OF REFUSE FROM SITE. 19. ELECTRICAL CONTRACTOR SHALL PROVIDE SHOP DRAWINGS FOR APPROVAL FOR ALL LIGHTING FIXTURES, PANELS, SWITCHES,

20. ELECTRICAL CONTRACTOR TO VERIFY LIGHTING FIXTURE MOUNTING REQUIREMENTS FOR VARIOUS CEILING TYPES AND ORDER APPROPRIATE HARDWARE

21. COORDINATE EXACT PLACEMENT OF EQUIPMENT WITH ELEVATOR AND MECHANICAL PLANS. MAKE FIELD ADJUSTMENTS AS

REQUIRED TO AVOID CONFLICTS, VERIFY WITH OWNER. 22. ELECTRICAL CONTRACTOR TO COORDINATE WITH ELEVATOR INSTALLER AND MECHANICAL CONTRACTOR FOR ITEMS SUPPLIED BY

THE MECHANICAL/OTHER DIVISIONS BUT INSTALLED BY THE ELECTRICAL CONTRACTOR. ELECTRICAL CONTRACTOR TO REVIEW ALL THE PLANS FOR THE PROJECT FOR ELECTRICAL WORK.

23. ELECTRICAL CONTRACTOR TO VERIFY ALL EQUIPMENT POWER NEEDS WITH THE ACTUAL SHOP DRAWINGS FOR THE EQUIPMENT TO BE USED, PRIOR TO STARTING ANY ELECTRICAL WORK.

24. SPECIFICATION SECTIONS, GENERAL CONDITIONS, SUPPLEMENTAL GENERAL CONDITIONS AND DRAWINGS ARE INTEGRAL PARTS OF CONTRACT DOCUMENTS

25. THE DISPOSAL OF ALL UNUSED EXISTING ELECTRICAL EQUIPMENT REMOVED IS A PART OF THE SCOPE OF WORK. THE ELECTRICAL CONTRACTOR SHALL DISPOSE OF ALL SUCH EQUIPMENT, INCLUDING HAZARDOUS PCB CONTAINING BALLASTS, IN A MANNER CONSISTENT WITH STATE OF CT. DEPARTMENT OF ENVIRONMENTAL PROTECTION REGULATIONS, CURRENT ISSUE.

26. SHARED NEUTRALS ARE NOT TO BE USED. PROVIDE SEPARATE NEUTRALS FOR ALL CIRCUITS.

27. PRIOR TO SUBMISSION OF BIDS GIVE WRITTEN NOTICE TO ARCHITECT AND ENGINEER OF ANY MATERIAL OR APPARATUS THAT IS INADEQUATE, UNSUITABLE FOR THE USE, IN VIOLATION OF LAWS, ORDINANCES, RULES, CODES OR ANY REGULATIONS OF AUTHORITIES HAVING JURISDICTION OR ANY NECESSARY ITEMS OF WORK THAT HAS BEEN OMITTED. CONTRACTOR AFFIRMS THAT IN ABSENT OF SUCH NOTICE, ALL SYSTEMS WILL FUNCTION SATISFACTORILY WITHOUT ADDITIONAL EXTRA COMPENSATION.

28. ALL PART NUMBERS ARE PROVIDED FOR THE CONVENIENCE OF THE CONTRACTOR. THEY ARE NOT TO BE CONSIDERED THE COMPLETE SPECIFICATION OF THE PRODUCT. THE PART NUMBER AND DESCRIPTION WILL BE THE COMPLETE SPECIFICATION. IN THE EVENT OF A DISCREPANCY BETWEEN THE TWO (2), THE MORE STRINGENT, MORE COSTLY FEATURE/PERFORMANCE WILL BE

29. FOR ALL GRADE LEVEL HVAC EQUIPMENT, THE ELECTRICAL CONTRACTOR SHALL SUPPLY A GFCI WP, 20A RECEPTACLE FOR EQUIPMENT SERVICING. ALL DISCONNECT SWITCHES ARE TO BE HEAVY DUTY, FUSED, WEATHER PROOF (WP) DEVICES.

30. NO LOW VOLTAGE WIRING SHALL BE PERMITTED IN THE SAME RACEWAY AS POWER WIRING.

31. FURNISH & INSTALL GFCI RECEPTACLES IN ALL WET LOCATIONS.

32. PROVIDE PULL STRINGS IN ALL EMPTY RACEWAYS.

EQUIPMENT.

RECEPTACLES, ETC.

33. CIRCUIT NUMBERS ARE INDICATED FOR INTENT ONLY. THE ELECTRICAL CONTRACTOR SHALL ADJUST ACCORDINGLY IN THE FIELD, TO BALANCE CIRCUITS EVENLY ON ALL PHASES.

34. MINIMUM CONDUCTOR SIZE, UNLESS OTHERWISE NOTED SHALL BE #12 FOR ALL BRANCH CIRCUIT RUNS UP TO THE FIRST OUTLET; OVER 100 FEET, #10; OVER 150 FEET, #8; INCREASE CONDUIT SIZE TO SUIT.

35. ELECTRICAL CONTRACTOR TO VERIFY LOADS, SETTINGS, OVERCURRENT PROTECTION, ETC. TO INSURE COMPATIBILITY OF

36. NO PENETRATIONS ARE ALLOWED INTO STAIR ENCLOSURES EXCEPT AS REQUIRED FOR SERVICES UTILIZED IN THE STAIR.


37. REPAIR AND REPLACE AT NO COST TO OWNER ALL EQUIPMENT AND MATERIALS DAMAGED DURING CONSTRUCTION. 38. ELECTRICAL CONTRACTOR SHALL COORDINATE ALL DEMOLITION WITH BASE BUILDING ELECTRICIAN.

39. PRODUCTS SHALL NOT BE INSTALLED IN PROMINENT LOCATIONS UNLESS NO ALTERNATIVE EXISTS. ITEMS SHALL BE CENTERED ON WALL OR CEILING TREATMENT AND ON ONE ANOTHER AS APPLICABLE. THIS INCLUDES BUT IS NOT LIMITED TO ACCESS PANELS, LIGHTING FIXTURES, SWITCHES, THERMOSTATS, FIRE ALARM DEVICES, EXIT SIGNS, ELECTRICAL PANELS, AND ANNUNCIATOR PANELS OF ANY KIND.


40. ELECTRICAL CONDUITS & BOXES SHALL BE CONCEALED IN WALLS OR ABOVE CEILINGS WHEREVER POSSIBLE.


41. INSTALLATIONS ON EXISTING WALLS SHALL BE RUN WITH SURFACE RACEWAY PAINTED TO MATCH WALL FINISH AND SURFACE BOXES. USE METAL WIREMOLD FOR INSTALLATIONS WITHIN OCCUPIED AREAS.


42. POWER RECEPTACLES COVER PLATES SHALL BE LABELED WITH DESIGNATED PANEL AND CIRCUIT NUMBER SERVING UNIT.

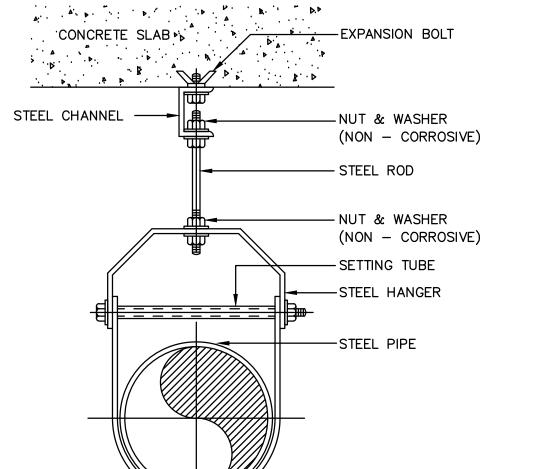



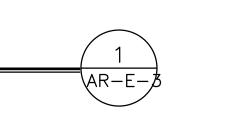


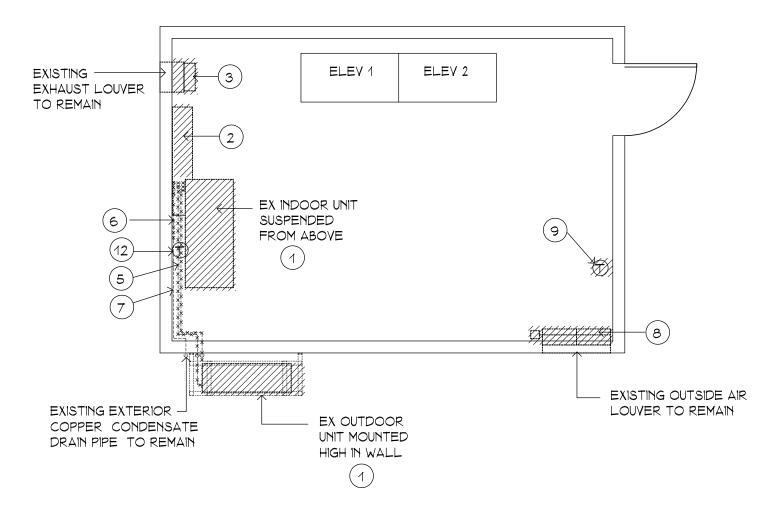


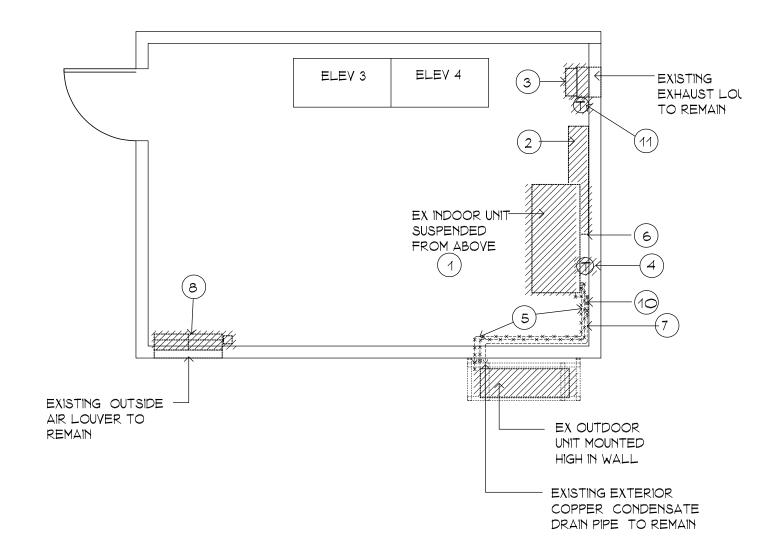





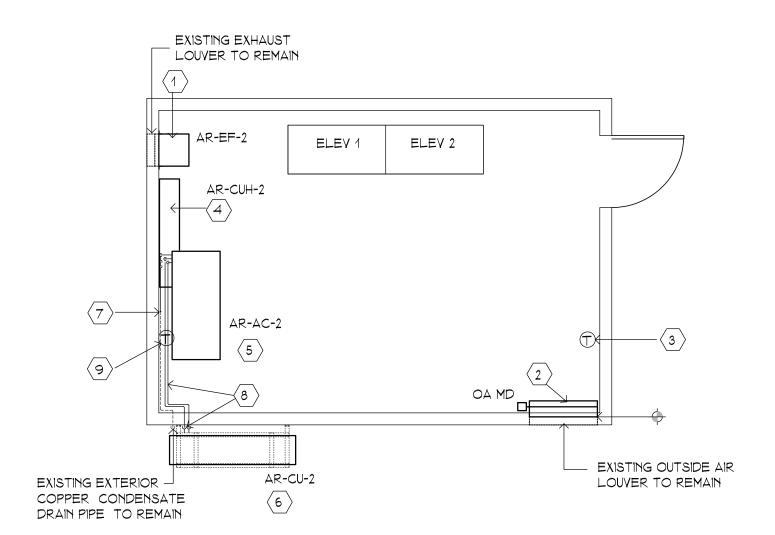

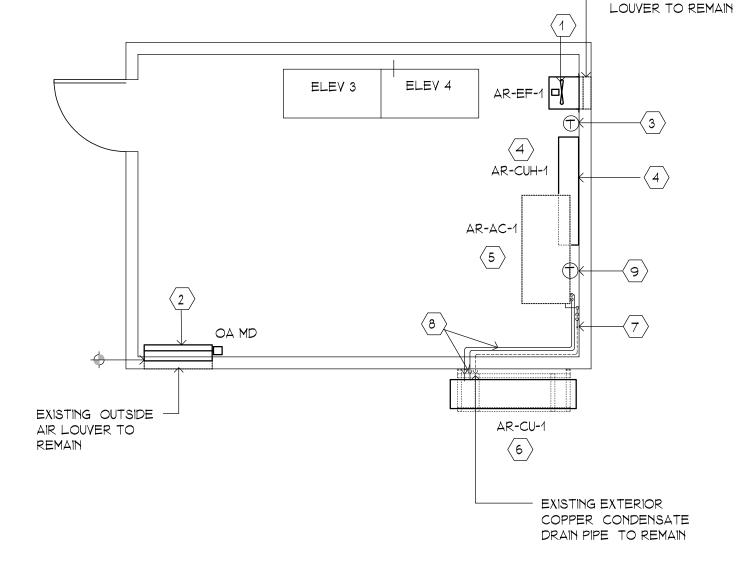

- EXISTING EXHAUST



AIR RIGHTS GARAGE LEVEL 9 EMR PLAN	4
SCALE: 1/4" = 1'-0"	AR-M-1

	SCHE	DULE FOR	R DUCTL	ESS	SPLI	TSYST	EM								(BASI	S OF DESIGN: TR	ANE/ MIT	-SUBISH
	INDOOR UNIT					OUTDOOR UNIT				COOLING PERFORMANCE				ELECTRICAL			RANT	
TAG	AREA SERVED	TYPE AND	WXHXD	WEIGHT		MODEL	·	WEIGHT	CAPACITY (BTU/HR)				V/PH/HZ	МСА	RFS	PIPING (IN) LIQUID / VAPOR	FRIGE	NOTE
		MODEL	INCH	(LBS)	TAG	HODEL		(LBS)	MINIMUM	RATED	EER	SEER		AMP	AMP		g, III	
AR-AC-1	LEVEL 9 EMR	CEILING SUSPENDED PCA-AK42NL	63 X 9.2 X 26.75	86	AR-CU-1	PUY-AK42NL	41.4 X 52.7 X 16.2	211	16,000	42,000	12	20.4	208-230/1/60	34	35	3/8 / 5/8	R454B	1 TO
AR-AC-2	LEVEL 10 EMR	CEILING SUSPENDED PCA-AK42NL	63 X 9.2 X 26.75	86	AR-CU-2	PUY-AK42NL	41.4 X 52.7 X 16.2	211	16,000	42,000	12	20.4	208-230/1/60	34	35	3/8 / 5/8	R454B	1 TC

NOTES	

- 1 PROVIDE DISCONNECT SWITCH
- 2 MANUFACTURER PROVIDED WALL MOUNTED WIRED CONTROLLER
- PROVIDE LOW AMBIENT WIND BAFFLE FOR COOLING OPERATION DOWN TO -40 DEG F. PROVIDE WITH WIND BAFFLE
- 4 INDOOR UNIT TO RECEIVE POWER FROM OUTDOOR UNIT THROUGH FIELD SUPPLIED INTERCONNECTING WIRING

ELECTRIC CABINET UNIT HEATER SCHEDULE (BASED ON QMARK													
TAG	LOCATION	CFM HEATING ELECTRICAL DATE			MODEL	NOTES							
			(KW)	VOLT/PH	А								
AR-CUH-1	LEVEL 9 EMR	500	14	480/3	18	CU945	1 , 2, 3						
AR-CUH-2	LEVEL 10 EMR	500	14	480/3	18	CU945	1 , 2, 3						

1. PROVIDE WITH 2-STAGE BUILT-IN THERMOSTAT

2.	PROVIDE WITH A THREE POLE NON-FUSED DISCONNECT SWITCH AND CIRC BREAKER SIZED TO THE HEATER WITH LOAD PROTECTION
3.	PROVIDE WITH TWO(2) TOOLHEAD KEYLOCK STYLE SPRING LATCHES TO PREVENT UNAUTHORIZED ADJUSTMENT OF CONTROLS.

AUST FAN SC	HEDULE									(BASED ON LO	REN COO!	
AREA				STATIC	FAN	ELECTRICAL		MOTOR				
SERVED	TYPE	CFM	(IN. WG.)	RPM	VOLTS/	HP	ENCLOSURE	RPM	MODEL	DAMPER ACTUATOR VOLTAGE	NOTES	
LEVEL 9 EMR	PROPELLER EXHAUST FAN	1200	0.125	1463	115/1	1/4	OPEN-EC	1725	12XWD-VF	115 V SHUTTER	1, 2	
LEVEL 10 EMR	PROPELLER EXHAUST FAN	1200	0.125	1463	115/1	1/4	OPEN-EC	1725	12XWPD-VF	115 V SHUTTER	1, 2	
	AREA SERVED LEVEL 9 EMR	SERVED TYPE LEVEL 9 EMR PROPELLER EXHAUST FAN PROPELLER PROPELLER	AREA SERVED TYPE CFM LEVEL 9 EMR PROPELLER EXHAUST FAN 1200 LEVEL 10 EMP PROPELLER 1200	AREA SERVED TYPE CFM STATIC PRESS (IN. WG.) LEVEL 9 EMR PROPELLER EXHAUST FAN 1200 0.125 PROPELLER 1200 0.125	AREA SERVED TYPE CFM STATIC PRESS (IN. WG.) FAN RPM LEVEL 9 EMR PROPELLER EXHAUST FAN 1200 0.125 1463 LEVEL 10 EMR PROPELLER 1200 0.125 1463	AREA SERVED TYPE CFM STATIC PRESS (IN. WG.) FAN ELECTRIC PRESS (IN. WG.) VOLTS/ LEVEL 9 EMR PROPELLER EXHAUST FAN 1200 0.125 1463 115/1 LEVEL 40 EMP PROPELLER 1200 0.125 1463 1467/1	AREA SERVED TYPE CFM STATIC PRESS (IN. WG.) FAN ELECTRICAL PRESS (IN. WG.) VOLTS/ HP LEVEL 9 EMR PROPELLER EXHAUST FAN 1200 0.125 1463 115/1 1/4 LEVEL 40 EMP PROPELLER 1200 0.125 1463 145/1 1/4	AREA SERVED TYPE CFM STATIC PRESS (IN. WG.) FAN ELECTRICAL MOTOR PRESS (IN. WG.) VOLTS/ HP ENCLOSURE LEVEL 9 EMR PROPELLER EXHAUST FAN 1200 0.125 1463 115/1 1/4 OPEN-EC PROPELLER 1200 0.125 1463 1463 145/4 1/4 OPEN-EC	AREA SERVED TYPE CFM STATIC PRESS (IN. WG.) LEVEL 9 EMR PROPELLER EXHAUST FAN 1200 0.125 1463 115/1 1/4 OPEN-EC 1725 PROPELLER 1200 0.125 1463 1463 1725	AREA SERVED TYPE CFM STATIC PRESS (IN. WG.) FAN ELECTRICAL MOTOR RPM VOLTS/ HP ENCLOSURE RPM MODEL LEVEL 9 EMR PROPELLER EXHAUST FAN 1200 0.125 1463 115/1 1/4 OPEN-EC 1725 12XWD-VF LEVEL 40 EMP PROPELLER 1200 0.125 1463 145/4 1/4 OPEN-EC 1725 12XWPD-VE	AREA SERVED TYPE CFM STATIC PRESS (IN. WG.) FAN ELECTRICAL MOTOR LEVEL 9 EMR PROPELLER EXHAUST FAN 1200 0.125 1463 115/1 1/4 OPEN-EC 1725 12XWD-VF 115 V SHUTTER PROPELLER 1200 0.125 1463 145/4 1/4 OPEN-EC 1725 12XWPD-VF 115 V SHUTTER	

DIRECT DRIVE PROPELLE FAN, PROVIDE WITH DISCONNECT SWITCH, EC MOTOR, MOTORIZED SHUTTER AND WALL COLLAR

PROVIDE WITH TEMPERATURE CONTROLLER LOREN COOK MODEL VFTC AND VARIFLOW AIR BALANCE KIT (VFABK). PROVIDE VFABK WITH 24-VOLT TRANSFORMER. INTERLOCK WITH THE EXHAUST FAN AND THE OA MOTORIZED DAMPER. CONTRACTOR TO PROVIDE ALL REQUIRED DEVICES AND INTERLOCK WIRINGS.

DEMOLITION LEGEND

SYMBOL	DESCRIPTION
%/////////////////////////////////////	EXISTING EQUIPMENT TO BE REMOVED
'H//////} OR ⊢×-×X	EXISTING PIPING O EQUIPMENT TO BE REMOVED

PLAN DEMOLITION NOTES

AND REPLACED.

- EXISTING DUCTLESS SPLIT SYSTEM TO BE REPLACED. DISCONNECT AND REMOVE EXISTING DUCTLESS SPLIT SYSTEM. DISCONNECT AND REMOVE EXISTING REFRIGERATION PIPING AND PIPING INSULATION. RECOVER EXISTING REFRIGERANT IN THE SYSTEM PRIOR TO DISCONNECTION. DSIPOSE RECOVERED REFRIGERANT IN ACCORDANCE WITH THE EPA REQUIREMENTS.
- 2 EXISTING ELECTRIC CABINET UNIT HEATER TO BE REMOVED AND REPLACED
- 3 EXISTING WALL MOUNTED PROPELLER EXHAUST FAN AND WALL COLLAR TO BE REMOVED AND REPLACED.
- EXISTING WIRELESS DUCTLESS SPLIT SYSTEM CONTROLLER TO BE REMOVED AND REPLACED
- (5) EXISTING REFRIGERATION PIPING AND INSULATION TO BE REMOVED
- 6 EXISTING CONDENSATE DRAIN TUBING FROM UNIT TO EXISTING COPPER CONDENSATE DRAIN PIPING TO BE REMOVED.
- (7) EXISTING COPPER CONDENSATE DRAIN PIPING TO REMAIN. REMOVE EXISTING INSULATION.
- (8) EXISTING MOTORIZED DAMPER AND ACTUATOR TO BE REMOVED
- AND REPLACED.
- (9) EXISTING WALL MOUNTED THERMOSTAT TO BE REMOVED AND REPLACED
- EXISTING PVC CONDENSATE DRAIN PIPING FROM UNIT TO EXISTING COPPER CONDENSATE DRAIN PIPING TO BE REMOVED.
- EXISTING THERMOSTAT MOUNTED ON EXHAUST FAN WALL COLLAR TO BE REMOVED AND REPLACED
- (12) EXISTING WALL MOUNTED WIRED DUCTLESS SPLIT SYSTEM CONTROLLER LOCATED BELOW INDOOR UNIT TO BE REMOVED AND REPLACED

CONSTRUCTION NOTES NUMBERED NOTES ARE APPLICABLE TO DRAWING SHEET ONLY

- NEW PROPELLER EXHAUST FAN. PROVIDE WITH WALL HOUSING MOUNTED AT FACE OF INTERIOR WALL. INSTALL IN ACCORDANCE WITH MANUFACTURER'S REQUIREMENTS. PROVIDE ANGLE SUPPORT AS REQUIRED. PROVIDE WITH 115 V MOTORIZED SHUTTER INTERLOCKED WITH THE EXHAUST FAN. MOUNT SHUTTER IN COLLAR IN ACCORDANCE WITH THE MANUFACTURER'S CLEARANCE REQUIREMENTS.
- NEW 36X14 OUTSIDE AIR DAMPER LOUVER PLENUM. COORDINATE WITH EXISTING LOUVER. BLANK OFF REMAINING UNUSED LOUVER OPENING. PROVIDE 36X14 OUTSIDE AIR MOTORIZED DAMPER WITH 115V ACTUATOR.
- EXH EXHAUST TEMPERATURE CONTROLLER LOREN COOK MODEL VFTC AND VARIFLOW AIR BALANCE KIT (VFABK), OR EQUIVALENT. PROVIDE VFABK WITH 24-VOLT TRANSFORMER. CONTROLLER WILL BE INTERLOCKED WITH THE EXHAUST FD FIRE DAMPER FAN AND THE OA MOTORIZED DAMPER. PROVIDE ALL REQUIRED DEVICES AND INTERLOCK WIRINGS.
- SURFACE WALL MOUNTED ELECTRIC CABINET UNIT HEATER. INSTALL IN ACCORDANCE WITH MANUFACTURER'S REQUIREMENTS
- DUCTLESS SPLIT INDOOR UNIT. INSTALL IN ACCORDANCE WITH THE $\langle 5 \rangle$ MANUFACTURER'S INSTALLATION AND CLEARANCE REQUIREMENTS. PROVIDE WITH WALL BRACKET
- SIDEWALL MOUNTED CONDENSING UNIT. PROVIDE WITH MOUNTING BRACKET SUITED FOR THE NEW CONDENSING UNIT SIZE AND WEIGHT. COORDINATE HEIGHT OF MOUNTING BRACKET IN FIELD.
- GENERAL LOCATION OF CONDENSATE DRAIN PIPING FROM INDOOR UNIT CONNECTION TO EXISTING COPPER CONDENSATE DRAIN PIPING. CONTRACTOR TO PROVIDE THE REQUIRED PITCH FOR GRAVITY DRAIN CONNECTION. COORDINATE IN FIELD. NEW AND EXISTING CONDENSATE DRAIN PIPING LOCATED INSIDE THE EMR SHALL BE PROVIDED WITH 1 /2 INCH THICK INSULATION
- INSULATED LIQUID AND GAS REFRIGERATION PIPING FROM INDOOR UNIT TO OUTDOOR UNIT. PROVIDE METAL JACKET FOR ALL EXPOSED EXTERIOR PIPING ALONG THE WALL. COORDINATE ROUTING IN FIELD. PROVIDE FIRESTOP CAULKING AT RATED WALL PENETRATION
- WIRED WALL MOUNTED DUCTLESS SPLIT SYSTEM CONTROLLER. PROVIDE WITH INTERLOCK WIRING

GENERAL 1. THE INTENT OF THESE CONTRACT DOCUMENTS IS FOR THE

SYMBOL LEGEND

REFERENCE, NUMBER INDICATES NOTE

EXISTING PIPING OR EQUIPMENT

EXISTING PIPING OR EQUIPMENT

FLEXIBLE DUCT

POINT OF CONNECTION

MOTORIZED DAMPER

FIRE DAMPER WITH

THERMOSTAT/SENSOR

PIPE ELBOW, TURNED DOWN

ACCESS DOOR

PIPE COUPLING

ABBREVIATIONS

(NOT ALL SYMBOLS ARE USED)

AC- # INDOOR AIR CONDITIONING UNIT

AFF ABOVE FINISHED FLOOR

CFM CUBIC FEET PER MINUTE

EAT ENTERING AIR TEMPERATURE

EER ENERGY EFFICIENCY RATIO

EMR ELEVATOR MACHINE ROOM

DEGREES FAHRENHEIT

EUH-# ELECTRIC UNIT HEATER

FLA FULL LOAD AMPERES

HORSEPOWER

INCHES

GC GENERAL CONTRACTOR

LEAVING AIR TEMPERATURE

MCA MINIMUM CIRCUIT AMPACITY

OAT OUTDOOR AIR TEMPERATURE

RPM REVOLUTIONS PER MINUTE

W/THERMAL OVERLOAD SIDE WALL REGISTER

TEMPERATURE DIFFERENCE

STATIC PRESSURE

SQ FT SQUARE FOOT (AREA)

ST SINGLE POLE SWITCH

THERMOSTAT

WMS WIRE MESH SCREEN

TEMP TEMPERATURE

TOT TOTAL

TYP TYPICAL

WITH WB WET BULB

WT WEIGHT (LBS)

MD MOTORIZED DAMPER

MFS MAXIMUM FUSE SIZE

CUH CABINET UNIT HEATER

AD ACCESS DOOR

CAP CAPACITY

DB DRY BULB

EX EXISTING

FEET

HTG HEATING

KW KILOWATT

MBH 1000 BTU'S

MIN MINIMUM

PH PHASE

RM ROOM

OA OUTSIDE AIR

LAT

DD DIRECT DRIVE

EF-# EXHAUST FAN

CONNECTION

TRANSITION

FIRE DAMPER

 \rightarrow

FD/AD

(NOT ALL SYMBOLS ARE USED)

	THE AUTHORITIES HAVING JURISDICTION AND READY FOR BENEFICIAL USE BY THE OWNER.
2.	THE CONTRACTOR SHALL OBTAIN AND REVIEW ALL CONTRACT DOCUMENTS, INCLUDING PROJECT MANUAL, PLANS AND SPECIFICATIONS OF ALL TRADES BEFORE SUBMITTING BID. REFER TO SPECIFICATIONS, PROJECT MANUAL AND PLANS, INCLUDING ALL EQUIPMENT SCHEDULES FOR MECHANICAL AND ELECTRICAL INFORMATION. CONTRACTOR SHALL WALK THROUGH BUILDING PRIOR TO SUBMITTING BID.
3.	ALL OF THE CONTRACT DRAWINGS AND SPECIFICATIONS

CONTRACTOR TO FURNISH AND INSTALL COMPLETE HVAC SYSTEMS. ALL SYSTEMS SHALL BE COMPLETE IN ALL

RESPECTS. OPERATING, TESTED, ADJUSTED, APPROVED BY

ARE COMPLEMENTARY TO FORM A TOTAL DESIGN PACKAGE. IT IS THE RESPONSIBILITY OF THE GENERAL CONTRACTOR/CONSTRUCTION MANAGER TO DETERMINE WHICH TRADE CONTRACTOR IS RESPONSIBLE FOR VARIOUS PORTIONS OF THE WORK.

4. ALL WORK AND ACTION DEPICTED AND DESCRIBED IN CONTRACT DOCUMENTS SHALL BE PERFORMED BY THE CONTRACTOR UNLESS SPECIFICALLY NOTED OTHERWISE.

THE DRAWINGS ARE DIAGRAMMATIC AND INDICATE THE GENERAL ARRANGEMENT OF SYSTEMS AND WORK INCLUDED IN THE CONTRACT. THE CONTRACTOR SHALL COORDINATE LOCATIONS OF EQUIPMENT WITH ALL TRADES BEFORE STARTING CONSTRUCTION. ANY MODIFICATIONS TO THE EQUIPMENT LAYOUT REQUIRED FOR INSTALLATION ARE TO BE PERFORMED AT NO ADDITIONAL COST TO THE OWNER.

6. WHEN CONFLICTS OCCUR BETWEEN THE DRAWINGS AND/OR SPECIFICATIONS IT SHALL BE BROUGHT TO THE ATTENTION OF THE ENGINEER. THE CONTRACTOR SHALL CARRY AS PART OF THE BID THE LARGER QUANTITY AND/OR MORE EXPENSIVE ITEM(S).

7 ALL WORK SHALL BE PERFORMED IN ACCORDANCE WITH THE REQUIREMENTS OF THE CONTRACT GENERAL CONDITIONS AND WITH THE PROVISIONS OF ALL APPLICABLE LOCAL, STATE, AND FEDERAL CODES AND LAWS. 8. ALL WORK AND ACTION DEPICTED AND DESCRIBED SHALL

BE PERFORMED BY THE CONTRACTOR. ITEMS AND SERVICES NOT SHOWN ON DRAWINGS OR SPECIFICATIONS BUT ARE REQUIRED TO RENDER THE WORK COMPLETE AND READY FOR OPERATION, SHALL BE PROVIDED WITHOUT ADDITIONAL

9. OBTAIN AND PAY FOR ALL REQUIRED PERMITS AND INSPECTIONS.

10. PROVIDE SUPPORT/BRACING OF EQUIPMENT AND BUILDING SERVICES AS REQUIRED BY THE BUILDING CODE.

REPAIR AND REPLACE AT NO COST TO OWNER ALL EQUIPMENT AND MATERIALS DAMAGED DURING CONSTRUCTION.

12. ALL EQUIPMENT, MATERIALS AND RELATED SYSTEMS COMPONENTS SHALL BE NEW UNLESS SPECIFICALLY NOTED OTHERWISE. 13. ALL EQUIPMENT, PIPING, DUCTWORK SHALL BE SUPPORTED

AS DETAILED, SPECIFIED AND REQUIRED TO PROVIDE A VIBRATION FREE INSTALLATION. 14 CONTRACTORS SHALL PROVIDE ALL REQUIRED SLEEVES AND SEALS FOR PIPES OR CONDUIT PENETRATING WALLS

OR FLOOR SLABS WITH FIRE STOPPING SEALANT WHERE

REQUIRED. PROVIDE VIBRATION ISOLATION FOR ALL MECHANICAL

16. INSTALL COMPLETE OPERATING SYSTEMS. PROVIDE ALL COMPONENTS, DEVICES, CONTROLS, RELAYS, TRANSFORMERS, ETC., WHETHER INDICATED OR NOT, FOR COMPLETE SYSTEMS AS INTENDED BY THE CONSTRUCTION DOCUMENTS.

17. ALL PENETRATIONS THRU RATED WALLS, FLOORS & CEILINGS SHALL BE SEALED USING U.L. LISTED METHODS APPROPRIATE FOR INDICATED RATING

18. PROVIDE ACCESS DOORS/PANELS FOR INSTALLATION IN WALLS AND/OR CEILINGS, WHERE REQUIRED, TO SERVICE FIRE DAMPER.

19. PROVIDE ACCESS DOORS/PANELS FOR INSTALLATION IN WALLS AND/OR CEILINGS, WHERE REQUIRED, TO SERVICE FIRE DAMPER.

ALTERATION WORK AND DEMOLITION

1. THE EXISTING CONDITIONS REPRESENTED HEREON ARE BASED ON GENERAL LOCATIONS OF EXISTING COMPONENTS IN THE FIELD AND ARE SHOWN ON THIS DRAWING FOR CONTRACTORS REFERENCE ONLY. ACTUAL LOCATION AND SIZE OF EQUIPMENT AND DUCTWORK AND EXTENT OF DUCTWORK ROUTING, PIPING AND EXTENT OF PIPING LENGTH AND ROUTING AND UTILITIES MAY VARY IN FIELD. MECHANICAL CONTRACTOR SHALL VERIFY LOCATIONS IN FIELD AND MAKE ALLOWANCE IN BID FOR LOCATIONS AND ARRANGEMENTS OTHER THAN SHOWN.

THE DEMOLITION NOTES ARE FOR DESCRIPTIVE GUIDE ONLY. THE CONTRACTOR SHALL BE RESPONSIBLE FOR THE REMOVAL OF ALL ITEMS WHETHER OR NOT INDICATED AND/ OR NOTED ON THE DRAWINGS. INCLUSION OF THESE EXISTING CONDITIONS HEREON SHALL IN NO WAY ALLEVIATE THE CONTRACTOR(S) OF HIS RESPONSIBILITY TO VISIT THE SITE

TO VERIFY ALL EXISTING CONDITIONS.

REMOVE, MODIFY AND REPLACE EXISTING SYSTEMS AS REQUIRED FOR INSTALLATION OF NEW HVAC SYSTEMS.

4 IT IS NOT THE INTENT OF THESE DRAWINGS TO SHOW EVERY PIECE OF EQUIPMENT, PIPING OR CONDUIT TO BE REMOVED. EQUIPMENT NOT BEING USED SHALL BE REMOVED INCLUDING ALL ASSOCIATED HANGERS, SUPPORTS, PIPES, DUCTS, CONDUITS, WIRES AND CONTROLS BACK TO THE POINT OF

5. ALL WASTE MATERIALS AND EQUIPMENT SHALL BE REMOVED FROM SITE AND SHALL BE LEGALLY DISPOSED BY THE CONTRACTOR.

NO EQUIPMENT, PIPING OR CONDUIT SHALL BE ABANDONED IN PLACE UNLESS SPECIFICALLY NOTED.

7 NO WORK SHALL BE LEFT INCOMPLETE NOR ANY HAZARDOUS SITUATIONS CREATED WHICH WILL AFFECT THE LIFE OR SAFETY OF THE PUBLIC AND/OR BUILDING OCCUPANTS. AT NO TIME SHALL THE WORK INTERFERE WITH OR CUTOFF ANY OF THE EXISTING SERVICES WITHOUT THE OWNER'S WRITTEN PERMISSION.

8 COORDINATE SHUTDOWN OF EXISTING SERVICES WITH OWNER'S MAINTENANCE PERSONNEL. NO WORK SHALL TAKE PLACE UNTIL DOING SO.

9. THE CONTRACTOR IS RESPONSIBLE FOR COORDINATING HIS WORK WITH ALL TRADES.

10. PIPING AND DUCT WORK LAYOUTS AS INDICATED ON THE DRAWINGS ARE DIAGRAMATIC: PROVIDE ADDITIONAL TRANSITIONS AND OFFSETS AS REQUIRED FOR CORDINATION WITH BUILDING CONSTRUCTION AND THE WORK OF OTHER TRADES.

11. PROVIDE FIRE DAMPERS AT DUCT PENETRATIONS OF FIRE RATED PARTITIONS.

12. MAINTAIN MANUFACTURER'S RECOMMENDED MINIMUM CLEARANCES FOR INSTALLATION OF EQUIPMENT.

13 INSTALL COMPLETE OPERATING SYSTEMS. PROVIDE ALL COMPONENTS, DEVICES, CONTROLS, RELAYS, TRANSFORMERS, ETC., WHETHER INDICATED OR NOT, FOR COMPLETE SYSTEMS AS INTENDED BY THE CONSTRUCTION DOCUMENTS.

14 THE TEMPERATURE CONTROL SYSTEM SHALL BE COMPLETE IN ALL REGARDS, TESTED AND CAPABLE OF ACHIEVING THE SEQUENCES OF OPERATION. ALL DEVICES SHALL BE UNDER SYSTEM CONTROL. ALL SPACES SHALL BE THERMOSTATICALLY CONTROLLED WHETHER OR NOT A THERMOSTAT, SENSOR OR CONTROLLER IS INDICATED.

REVISIONS DRAWING TITLE AIR RIGHTS GARAGE GROUND FLOOR AND

NO. DATE BY

ROOF EMR PLANS DRAWING NO.


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SCALE: AS NOTED

DATE: JULY 2025 PROJECT NO. 20-20176.00-2 NHPA NO. 21-011 DESIGN DRAWN CH'KD AMG AMG RRB

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APPROXIMATE LOCATION OF EXISTING ELECTRICAL PANEL RATED 225A, 120/208V-3PH, 4 WIRE SERVING ELEVATOR CAB LIGHTING, M.R.

BREAKERS AND UPDATE PANEL DIRECTORY WITH NEW BREAKER DESIGNATION.

WITH ADDRESS MODULE FOR EACH.

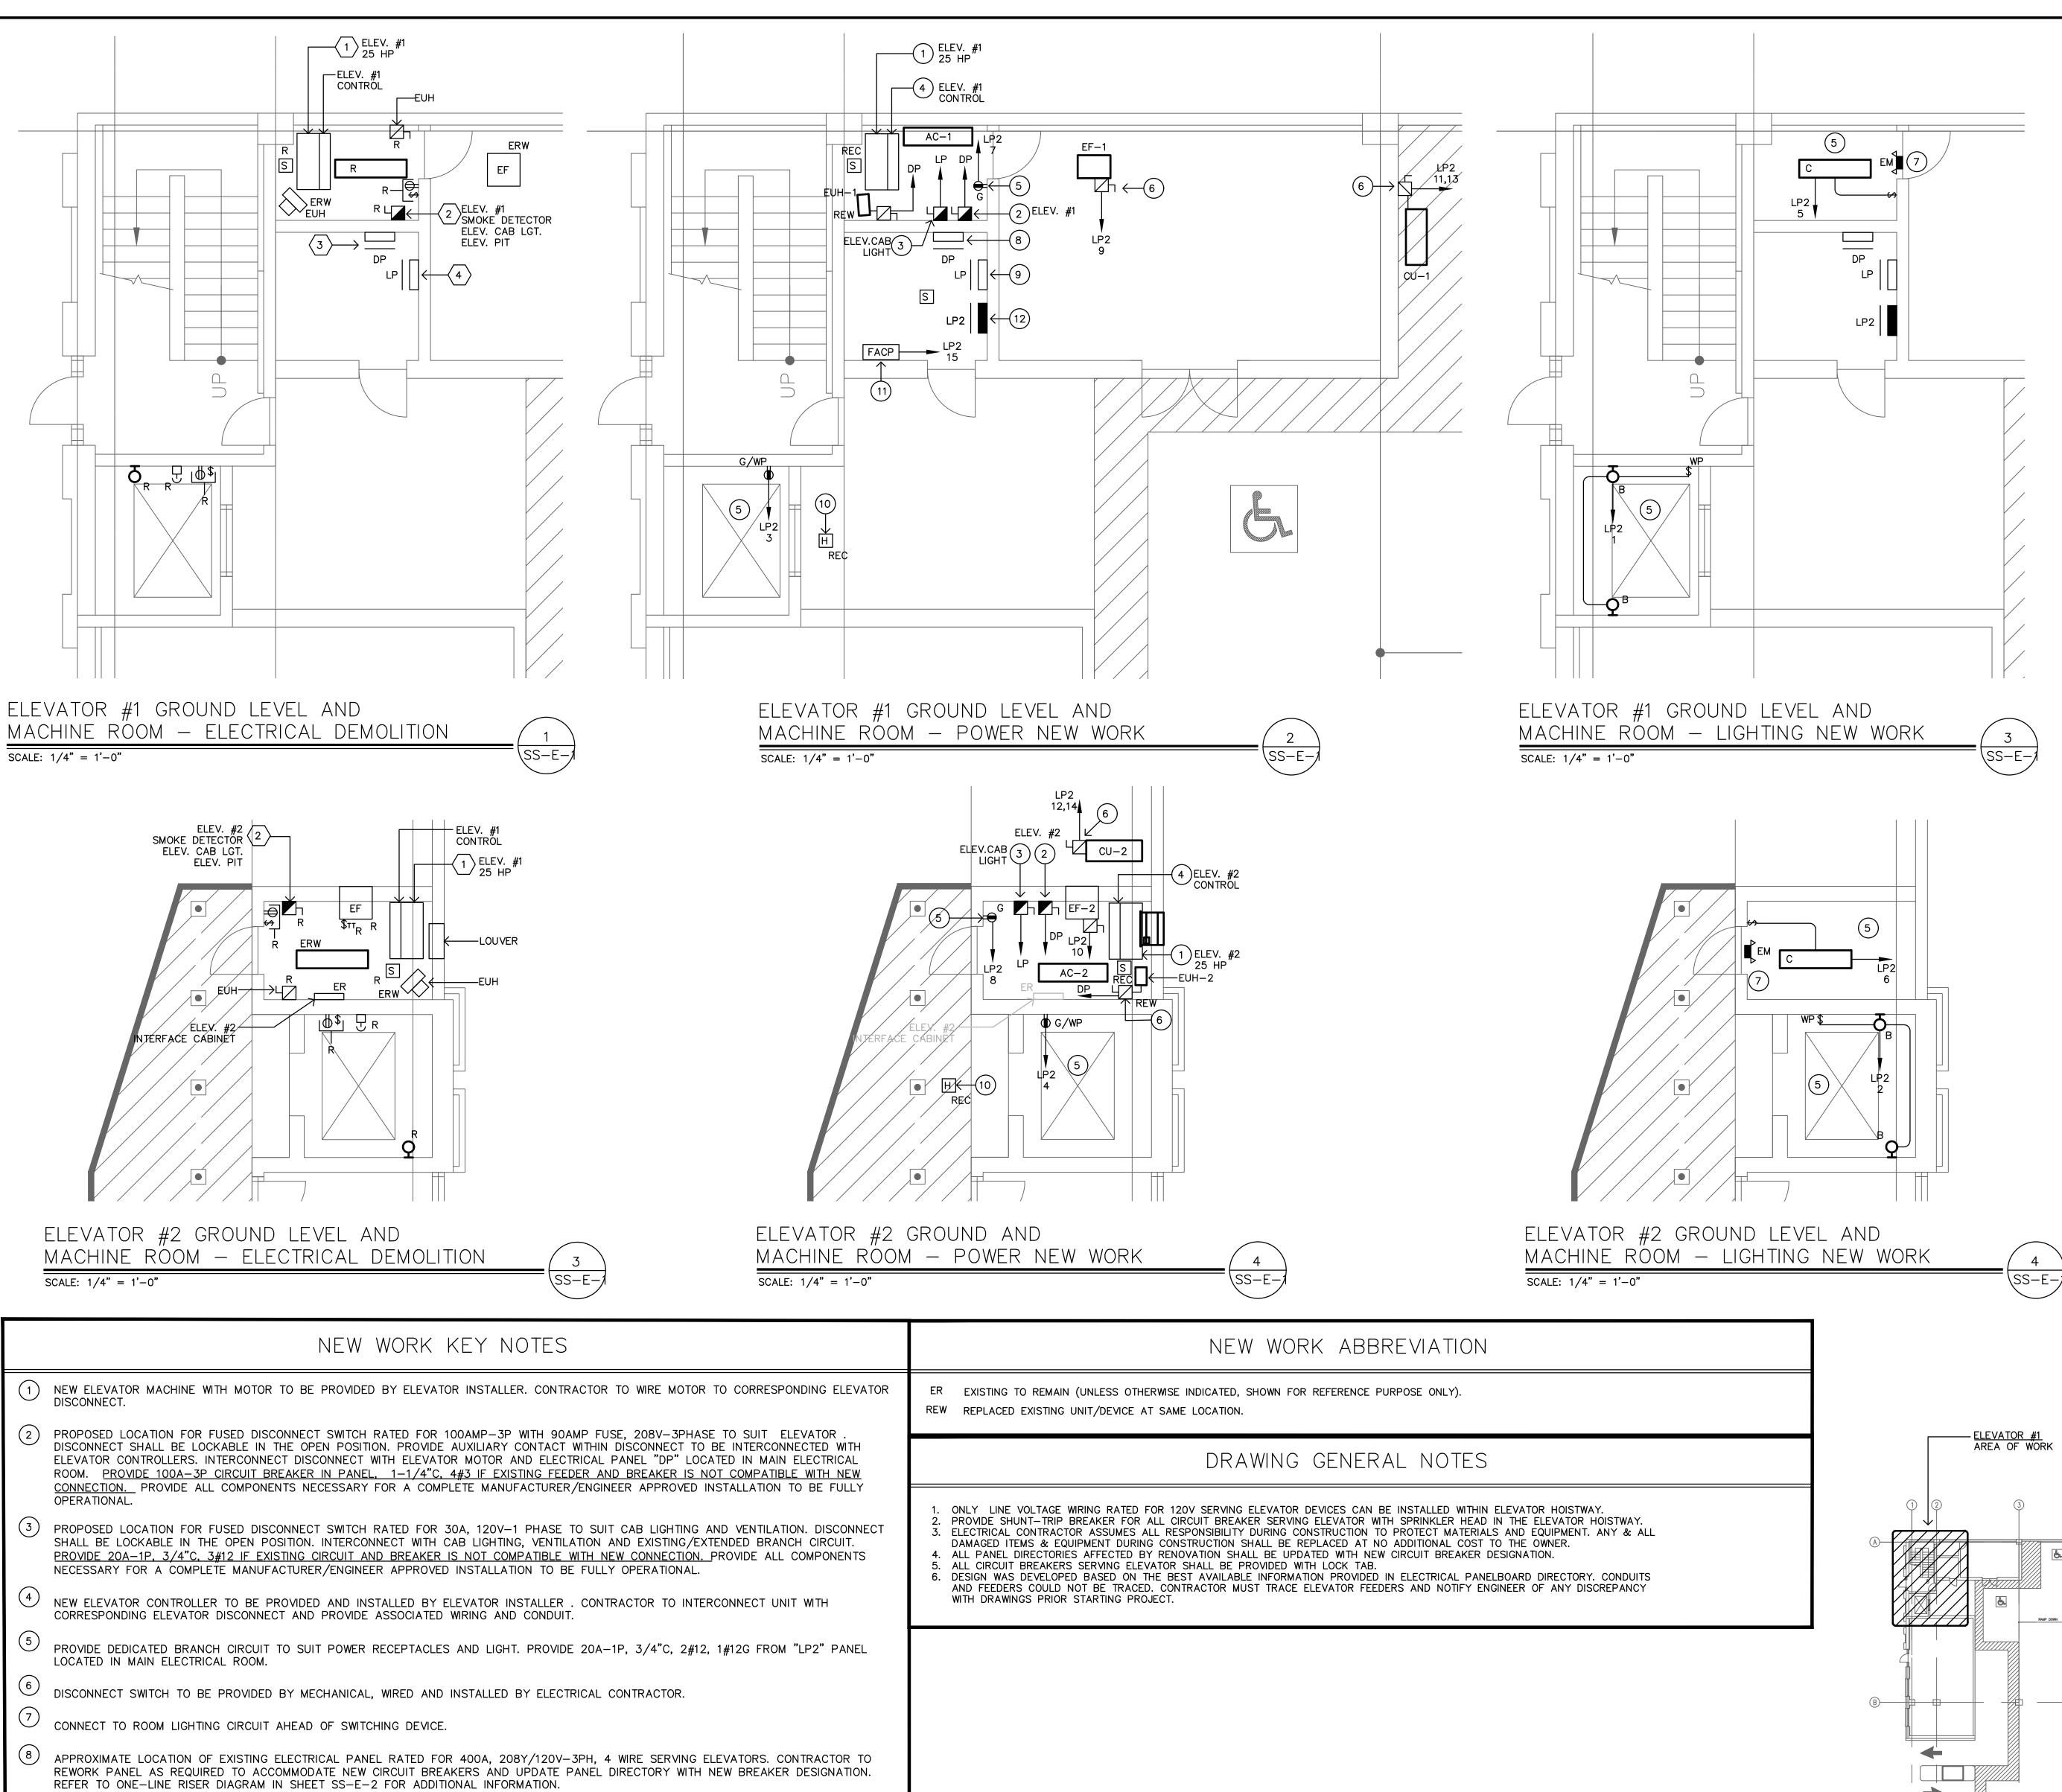RISER DIAGRAM FOR ADDITIONAL INFORMATION.

LIGHTING, POWER RECEPTACLE AND ELEVATOR CONTROLLERS. CONTRACTOR TO REWORK PANEL AS REQUIRED TO ACCOMMODATE NEW CIRCUIT

PROVIDE NEW ELEVATOR RECALL HEAT DETECTOR FOR EACH OF THREE LANDINGS. DEVICE SHALL BE NON-ADDRESS, COLD TEMPERATURE TYPE

PROPOSED LOCATION FOR NEW FIRE ALARM CONTROL PANEL. CONTROL PANEL SHALL BE FURNISHED WITH ALL COMPONENTS REQUIRED TO

SERVE DEVICE SHOWN ON DRAWING. PROVIDE TWO TELEPHONE LINES AND ALL NECESSARY MATERIAL AND ACCESSORIES FOR A COMPLETE

PROPOSED LOCATION FOR NEW ELECTRICAL PANEL LP2 RATED FOR 60A, 120/240V-1PH. REFER TO PANELBOARD SCHEDULE AND ONE-LINE

INSTALLATION TO BE FULLY OPERATIONAL. COORDINATE FINAL LOCATION WITH FIRE MARSHAL PRIOR INSTALLATION.

DEMOLITION KEY NOTES


- APPROXIMATE LOCATION OF EXISTING ELEVATOR MOTOR TO BE DISCONNECTED BY ELECTRICAL CONTRACTOR. REMOVE ASSOCIATED WIRING AND CONDUIT BACK TO DISCONNECT SERVING ELEVATOR.
- APPROXIMATE LOCATION OF EXISTING ELEVATOR DISCONNECT TO BE REPLACED. CONTRACTOR TO RETAIN ASSOCIATED FEED AND CONDUIT TO SUIT NEW UNIT
- APPROXIMATE LOCATION OF EXISTING ELECTRICAL PANEL RATED 400A, 208Y/120V-3PH, 4 WIRE SERVING ELEVATOR. REFER TO NEW WORK FOR ADDITIONAL INFORMATION.
- APPROXIMATE LOCATION OF EXISTING ELECTRICAL PANEL RATED 225A, 120/208V-3PH, 4 WIRE SERVING ELEVATOR CAB LIGHTING, M.R. LIGHTING, POWER RECEPTACLE AND ELEVATOR CONTROLLERS. REFER TO NEW WORK FOR ADDITIONAL INFORMATION.

DEMOLITION ABBREVIATION

- ER EXISTING TO REMAIN (UNLESS OTHERWISE INDICATED, SHOWN FOR REFERENCE PURPOSE ONLY).
- ERW EXISTING UNIT/DEVICE TO BE REPLACED AT SAME LOCATION. CONTRACTOR TO RETAIN ASSOCIATED WIRING AND CONDUIT TO SUIT NEW. REFER TO NEW WORK FOR ADDITIONAL INFORMATION.
- EXISTING TO BE REMOVED. CONTRACTOR TO REMOVE ASSOCIATED DEVICES, WIRING AND CONDUIT BACK TO SOURCE

DEMOLITION GENERAL NOTES

- 1. UNLESS OTHERWISE INDICATED, THE ELECTRICAL CONTRACTOR SHALL REMOVE ALL INDICATED ELECTRICAL EQUIPMENT, ACCESSORIES, CONTROLS, DEVICES, AND ASSOCIATED CONDUIT AND WIRING BACK TO SOURCE OR LAST DEVICE.
- 2. NO EQUIPMENT OR DEVICES THAT HAVE BEEN DISCONNECTED AND/OR ABANDONED SHALL REMAIN.
- 3. THE ELECTRICAL CONTRACTOR SHALL VISIT THE SITE AND BECOME FAMILIAR WITH THE EXISTING SYSTEMS AND CONDITIONS IN AREAS OF RENOVATION.
- 4. ANY SYSTEMS OR EQUIPMENT TO REMAIN ACTIVE DURING RENOVATION SHALL BE KEPT IN OPERATION BY PROVIDING TEMPORARY CONNECTIONS AS REQUIRED UNTIL NEW SYSTEMS ARE INSTALLED AND OPERATIONAL.
- 5. THE ELECTRICAL CONTRACTOR SHALL COORDINATE WITH THE OWNER, CM, AND/OR GENERAL CONTRACTOR ANY AND ALL PHASING OF THE MECHANICAL DEMOLITION WORK IN ORDER TO SATISFY THE CONSTRUCTION SCHEDULE AND OWNER'S OCCUPANCY REQUIREMENTS.
- 6. ANY ELECTRICAL EQUIPMENT TO BE REMOVED AND REUSED OR TURNED OVER TO THE OWNER, AT OWNERS REQUEST, OR AS INDICATED ON THE DRAWINGS SHALL BE CAREFULLY REMOVED AND STORED TO PREVENT
- 7. THE ELECTRICAL CONTRACTOR SHALL ALSO REVIEW THE ARCHITECTURAL DEMOLITION DRAWINGS AS PART OF THIS CONTRACT FOR ADDITIONAL INFORMATION AND REQUIREMENTS.
- 8. ALL SERVICE INTERRUPTIONS SHALL BE COORDINATED AND APPROVED WITH THE OWNER IN ADVANCE PRIOR TO COMMENCEMENT OF ANY WORK.
- 9. THE ELECTRICAL CONTRACTOR SHALL COORDINATE HIS DEMOLITION WORK WITH THAT OF OTHER TRADES IN ORDER TO AVOID CONFLICTS.
- 10. ELECTRICAL COMPONENTS SHOWN ON THE DEMOLITION DRAWINGS, AND THE ASSOCIATED CONDUIT, WIRE & BOXES ARE TO BE REMOVED AND DISPOSED OF UNLESS SPECIFICALLY NOTED OTHERWISE.
- 11. ALL MATERIALS BEING REMOVED SHALL BE HANDLED IN A MANNER COMPLYING WITH ALL PERTINENT LAWS, CODES AND ENVIRONMENTAL REGULATIONS.
- 12. ALL REMOVED COMPONENTS SHALL BE LEGALLY DISPOSED OF BY CONTRACTOR UNLESS SPECIFICALLY NOTED OTHERWISE.
- 13. WHERE EXISTING DEVICES ARE REMOVED & NO NEW DEVICES ARE INSTALLED IN THE SAME LOCATION, REMOVE ALL WIRING FROM BOX & PROVIDE PROPERLY SIZED BLANK COVER PLATE.
- 14. WHERE ELECTRICAL EQUIPMENT & DEVICES ARE BEING REMOVED, COORDINATE AND FIELD VERIFY IF BRANCH CIRCUIT FEEDS THROUGH TO EQUIPMENT/DEVICES TO REMAIN. BRANCH CIRCUITS SHALL BE SPLICED OR RELOCATED TO MAINTAIN CONTINUATION OF SERVICES.

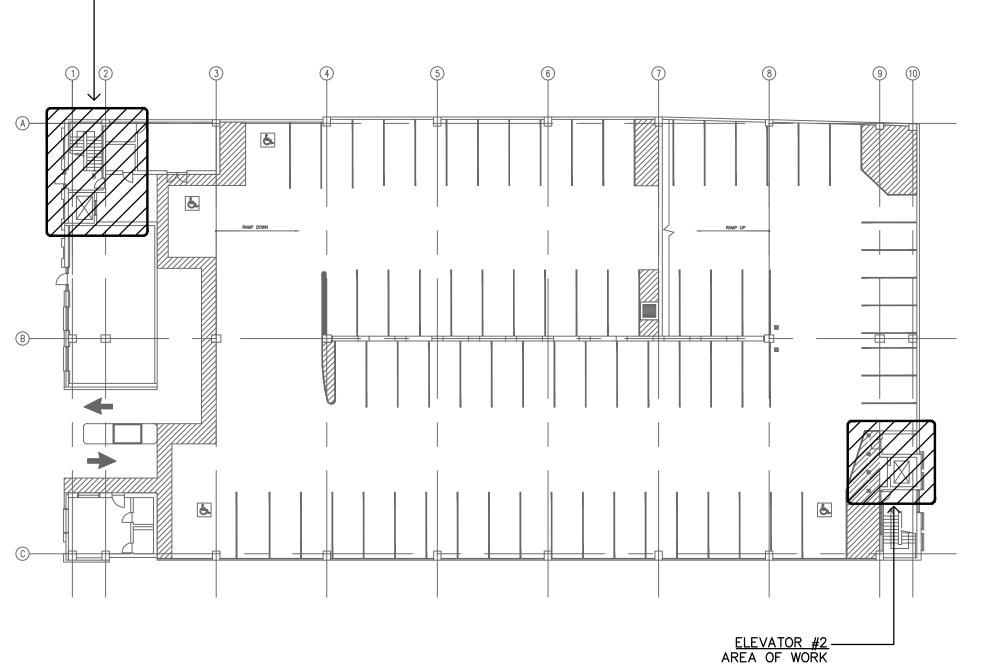

OVERALL KEY PLAN

NOT TO SCALE



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NO. DATE BY

DRAWING TITLE STATE STREET-ELECTRICAL


DRAWING NO. SS-E-1

SCALE: AS NOTED DATE: JULY 2025

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THIRD FLOOR FIRE ALARM PLAN SCALE: 1/16" = 1'-0"



<u>FIRE ALARM SYSTEM RISER DIAGRAM</u> NOT TO SCALE

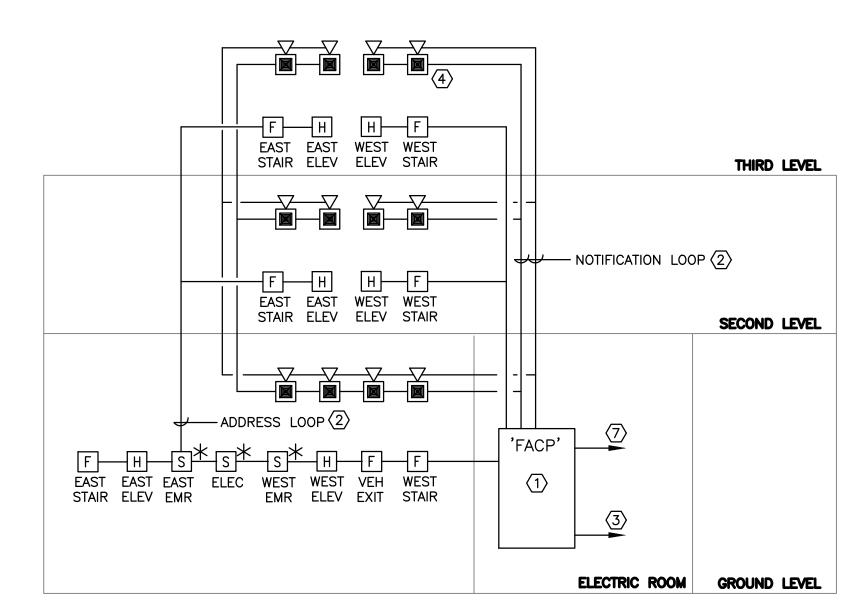FIRE ALARM RISER DIAGRAM


- 1 NEW FIRE ALARM CONTROL PANEL. SEE SPECS FOR DETAILS.
- (2) LOOP WIRING TO BE SIZED FOR VOLTAGE DROP FROM THE FACP. ALL WIRING TO BE PER SPECIFICATIONS AND MANUFACTURER'S REQUIREMENTS. ALL WIRING TO BE IN CONDUIT.
- PROVIDE 120V, 20A-1P BRANCH CIRCUIT (#6) FROM PANEL LP1. PROVIDE LOCKING CIRCUIT BREAKER FOR CONTROL
- ON THE TOP AND SIDES OF THE BOX TO ENSURE WEATHERPROOF RATING. INSTALL STROBES AT A MAXIMUM OF 8

4 FIRE ALARM HORN/STROBE UNITS THAT ARE MOUNTED ON ROOFTOP LIGHT POLES ARE TO BE SEALED WITH SILICONE


- FURNISH DEVICES WITH ALL NECESSARY MATERIALS AND ACCESSORIES REQUIRED FOR COMPLETE INSTALLATION TO BE FULLY OPERATIONAL. SIZE OF CONTROL PANEL SHALL HAVE SUFFICIENT CAPACITY FOR ALL DEVICES. PROVIDE BATTERY BOOSTER WHERE REQUIRED.
- 6. FIRE ALARM CONTRACTOR TO PROVIDE END OF LINE RESISTORS AT END OF LOOPS.
- 7. ALL STROBES ARE TO BE SYNCHRONIZED. PROVIDE SYNC MODULES.
- 8. MOUNTING HEIGHTS TO CENTER OF BACK BOX: HORN/STROBES AND STROBE LIGHTS - 84" AFF OR 12" BELOW CEILING (WHICHEVER IS LOWER). HEIGHT ALSO APPLICABLE FOR POLE MOUNTED STROBES ON ROOF. PULL STATIONS - 48" AFF
- 9. EXACT LOCATIONS OF FIRE ALARM DEVICES TO BE COORDINATED IN FIELD AND ARE NOT TO CONFLICT WITH ANY
- 10. PAINT ALL J-BOX COVERS IN RED AND LABEL AS "FIRE ALARM".
- 11. FURNISH DETECTORS WITH MANUFACTURER'S BASES.
- 12. PROVIDE ONE-LINE DIAGRAM PRODUCED BY MANUFACTURER'S AGENT/REP. ALL FIRE ALARM DEVICES SHALL BE MANUFACTURED AND LISTED FOR USE WITH THE PANEL.
- 13. ANY SURFACE MOUNTED DEVICES TO BE FURNISHED WITH MANUFACTURER'S SKIRT TRIM, BACK BOX AND SURFACE MOUNTING KIT.
- 14. ALL DEVICES SHALL BE SUITABLE FOR WET LOCATIONS AND RATED FOR OUTDOOR USE. THESE DEVICES TO BE FULLY GASKETED.

16. ALL PULL STATIONS AND SPEAKER STROBES ARE TO BE FED FROM THE BOTTOM OF THE

- DEVICE. DRIP LOOPS FROM LFMC CONDUIT ARE TO BE PROVIDED AT EACH DEVICE TO PREVENT MOISTURE FROM ENTERING. REFER TO MOUNTING DETAIL ON THIS SHEET.
- 17. FIRE ALARM INITIATING DEVICES WHICH ARE LOCATED OUTSIDE OF TEMPERATURE CONTROLLED AREAS ARE TO BE NON-ADDRESSABLE.
- 18. FINAL ACCEPTANCE TESTING SHALL BE CONDUCTED PRIOR TO ISSUANCE OF CO PER NFPA

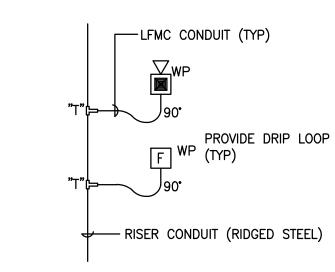


TYPICAL MOUNTING FOR GARAGE AREA FOR ADDITIONAL PROTECTION FROM MOISTURE

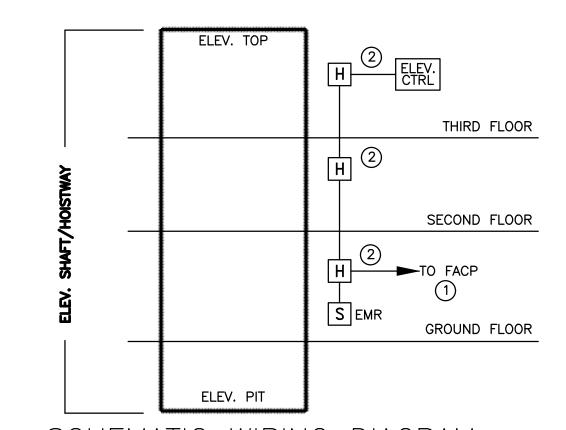


SCHEMATIC WIRING DIAGRAM ELEVATOR RECALL SMOKE DETECTORS


- (1) TIE INTO FIRE ALARM CONTROL PANEL LOCATED IN ELECTRICAL ROOM 001.
- 2 PROVIDE ELEV. RECALL HEAT DETECTORS TO BE INSTALLED IN ELEV. SHAFT (TOP) AND AT EACH ELEV. DOOR OPENING ON EACH LEVEL/LANDING. DETECTORS ARE TO BE NON-ADDRESSABLE WITH ADDRESSABLE MODULE FOR EACH.
- 3. ALL WIRING PER FIRE ALARM SYSTEM MANUFACTURER'S REQUIREMENTS.
- 4. TYPICAL DEVICES SHOWN. REFER TO DWGS FOR QUANTITY.
- COORDINATE ADDITIONAL REQUIREMENTS WITH ELEV. AND FIRE ALARM MANUFACTURERS AND CONTRACTORS.
 - ONE (1) FOR TYPICAL LOBBY DETECTOR(S) ONE (1) FOR DESIGNATED LEVEL LOBBY DETECTOR(S) ONE (1) FOR THE SHAFT/HOISTWAY DETECTOR(S)

6. THREE SEPARATE "SIGNALS" TO BE PROVIDED: -

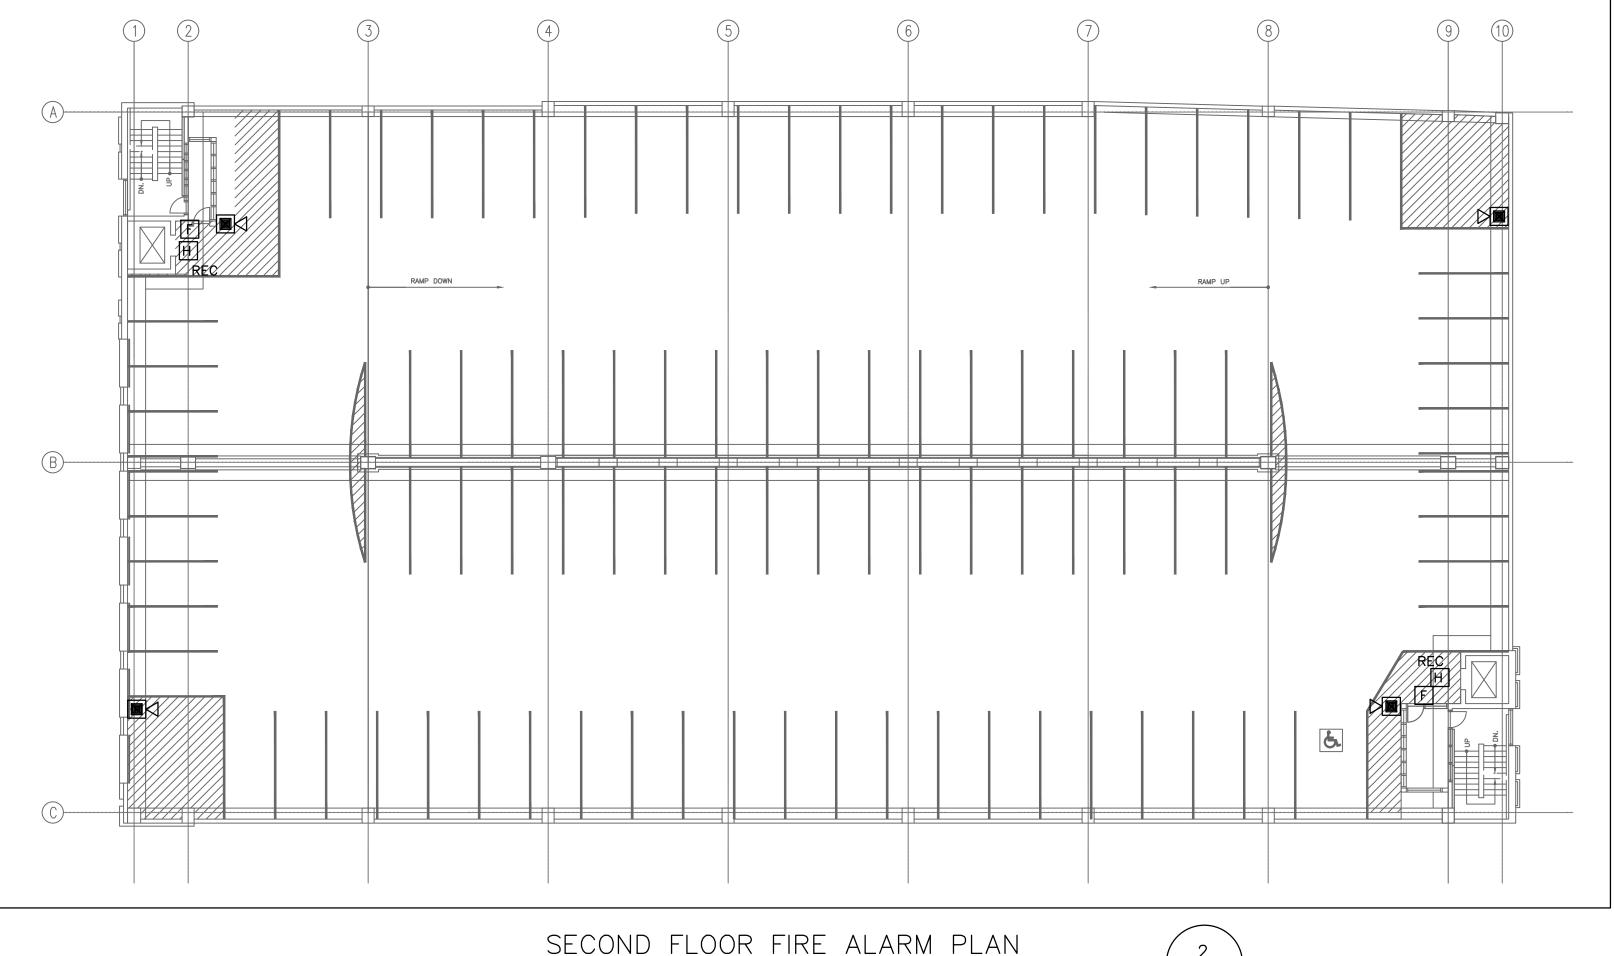


SECOND FLOOR FIRE ALARM PLAN SCALE: 1/16" = 1'-0"

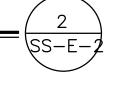

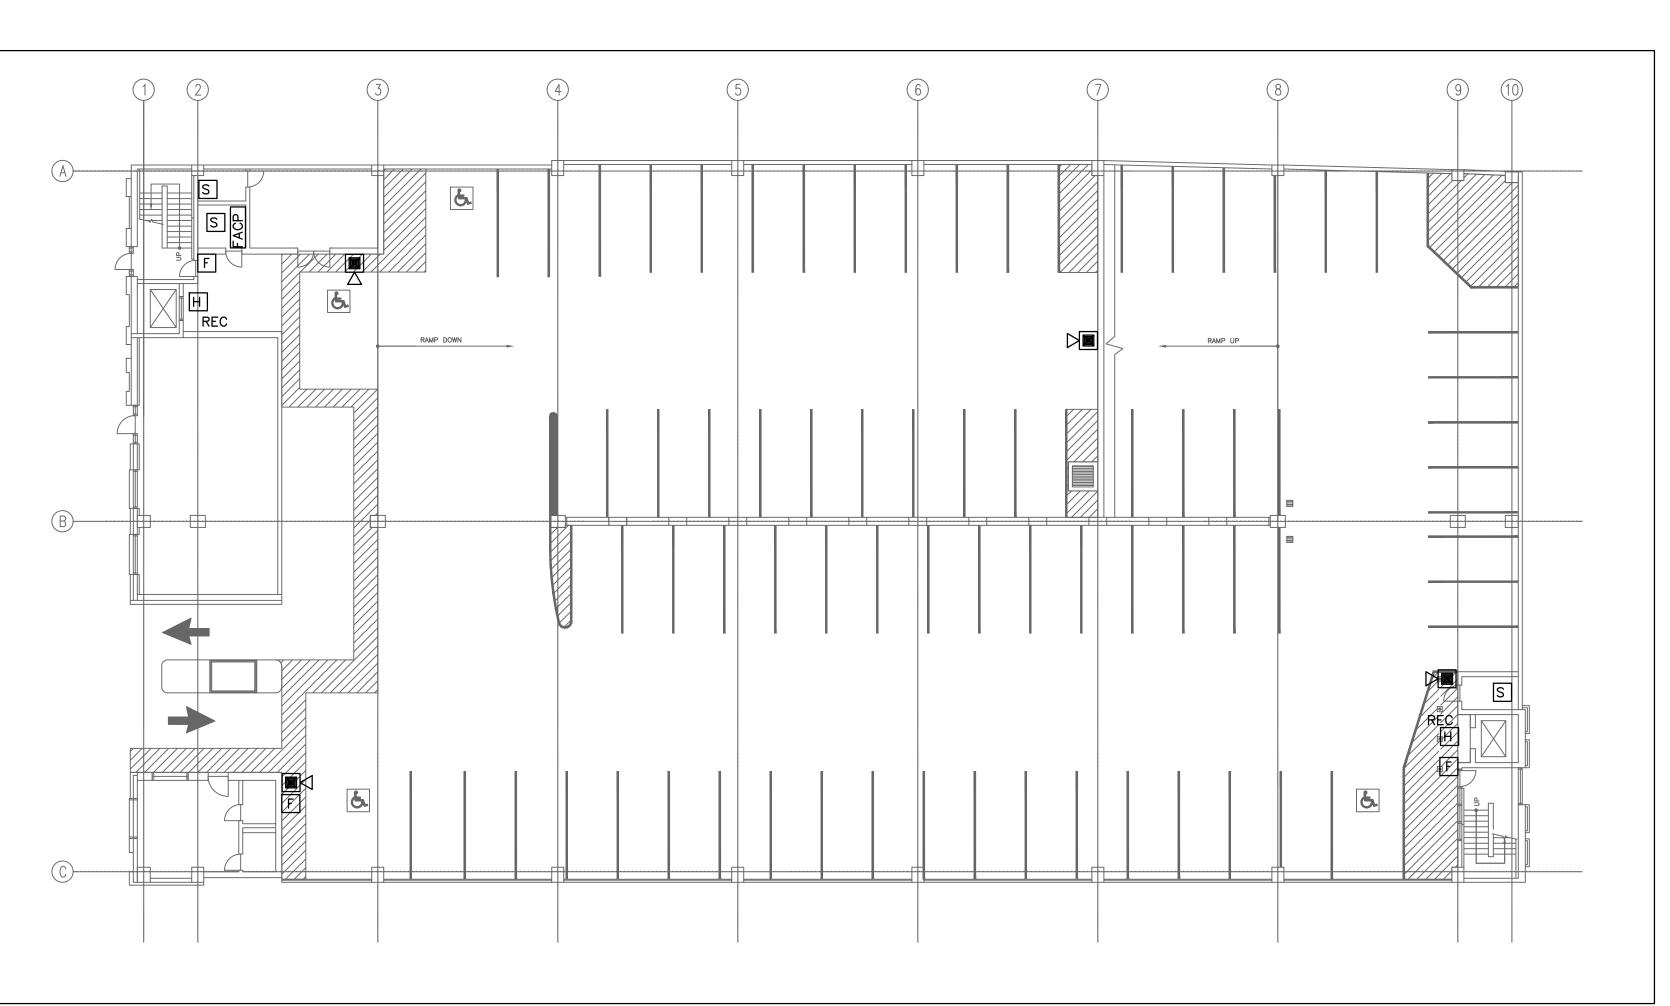

GROUND FLOOR FIRE ALARM PLAN

SCALE: 1/16" = 1'-0"

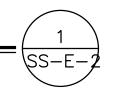

NO. DATE BY

REVISIONS DRAWING TITLE STATE STREET-FIRE ALARM PLANS

DRAWING NO. SS-E-2

SCALE: AS NOTED DATE: JULY 2025


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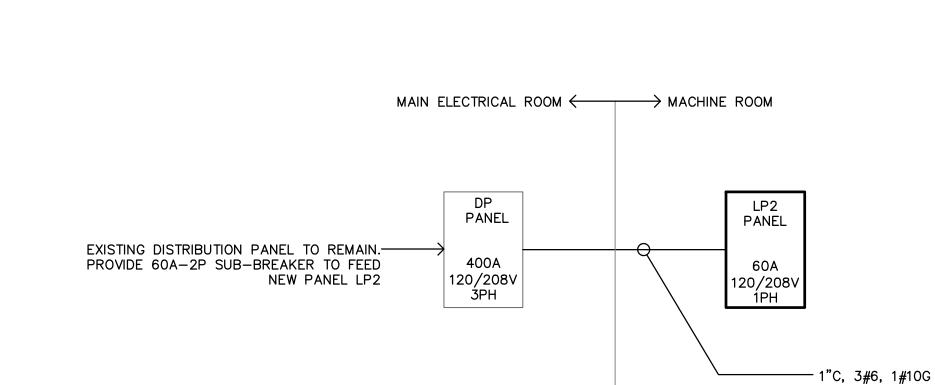
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NOTES

- (1) FURNISH WITH ALL REQUIRED MOUNTING HARDWARE AND CONNECTING CABLE.
- (2) ALL FIXTURES SHALL BE CAPABLE OF OPERATING IN COLD TEMP (0° F).

	— CONDUIT AND WIRE — CONDUIT AND WIRE, SWITCHED CKT-X BRANCH CIRCUIT HOMERUN.
RATINGS: 60A MCB PANEL LP2 LOCATION: ELECTRICAL ROOM 22,000 AIC	ABBREVIATION
SERVICE: 120/208V, 1 PH/4-WIRE MOUNTING: SURFACE DESCRIPTION NOTE AMPS TRIP AMP POLE CKT. CKT. NO. A B CKT. CKT. NO. TYP POLE TRIP AMP NOTE DESCRIPTION	G GROUND FAULT INTERRUPTER WP WEATHERPROOF



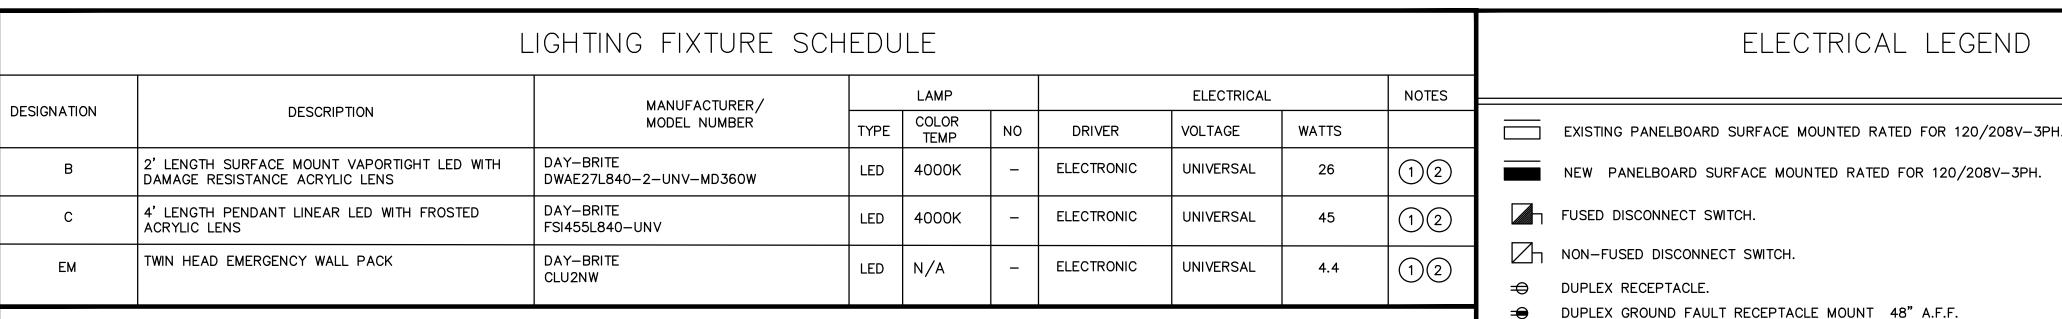


H WALL MOUNTED LIGHT FIXTURE.

SUSPENDED LINEAR WALL MOUNTED LIGHT FIXTURE

SINGLE-POLE SWITCH; MOUNT AT 48" AFF.

FIRE ALARM SHUNT TRIP HEAT DETECTOR.

FIRE ALARM SMOKE DETECTOR.

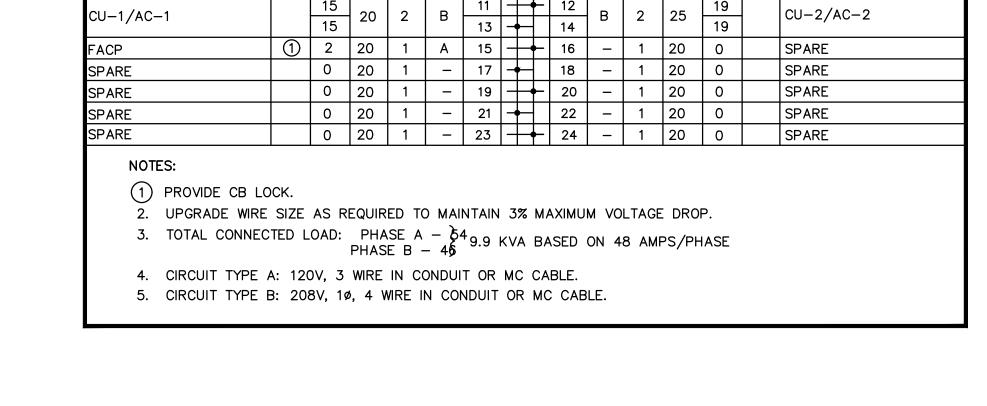


1 | 20 | 1 | A | 1 | + + | 2 | A | 1 | 20 | 1 | ELEV. #2 PIT LIGHTING

| 6 | 20 | 1 | A | 9 | | | | 10 | A | 1 | 20 | 6 | | EF-2

1.6 20 | 1 | A | 7 | | | | | 8 | A | 1 | 20 | 1.6 | | M.R. #2 RECEPTACLE

| 1.6 | 20 | 1 | A | 3 | | | | | 4 | A | 1 | 20 | 1.6 | | | ELEV. #2 PIT RECEPTACLE

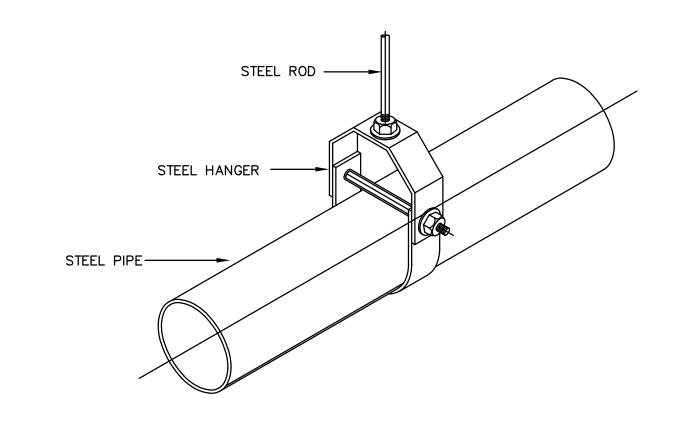


LEV. #1 PIT LIGHTING


I.R. #1 RECEPTACLE

I.R. #1 LIGHTING


LEV. #1 PIT RECEPTACLE

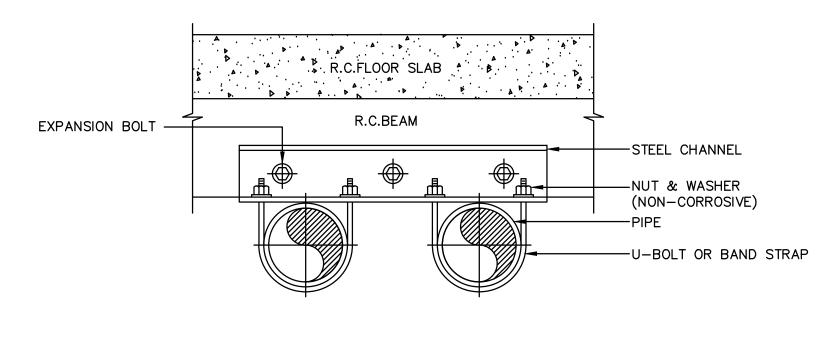

END VIEW

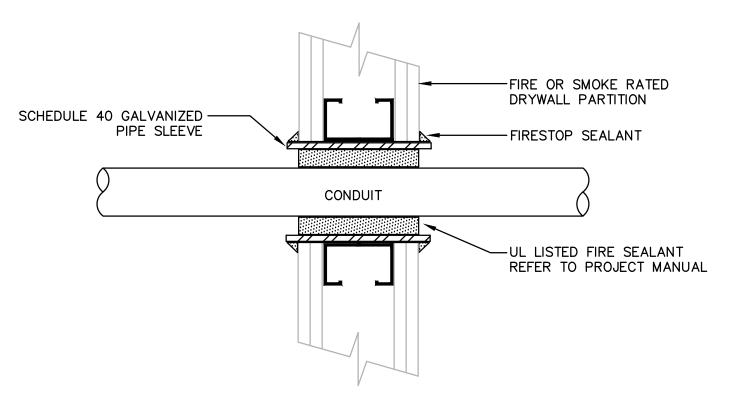



ELECTRICAL LEGEND

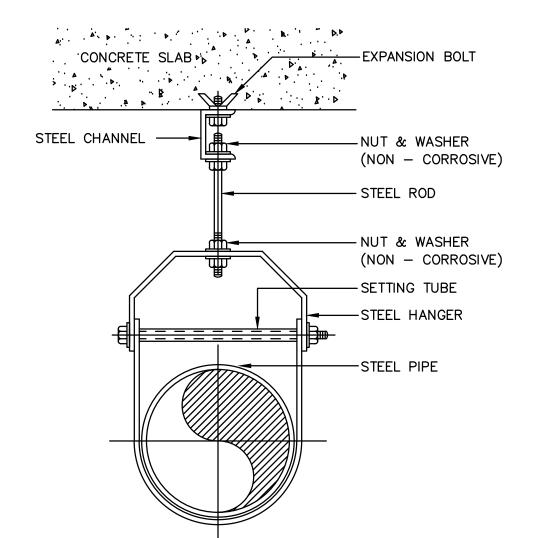

SS-E-J


PIPE HANGER DETAIL

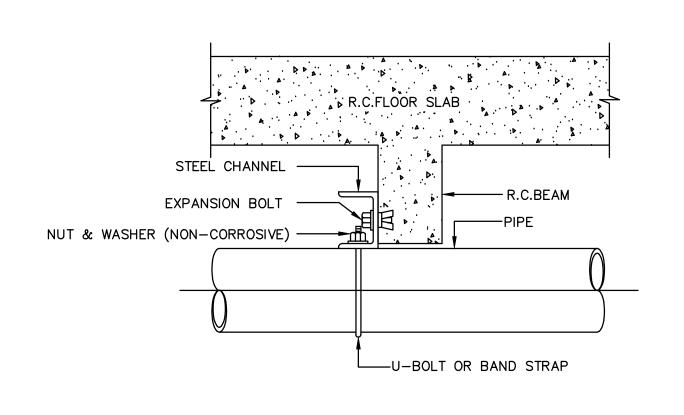

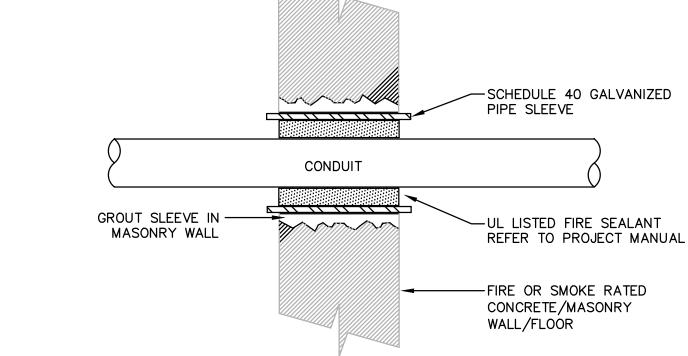

ELEVATION

PIPE HANGER FROM BEAM

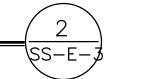

WALL/FLOOR PENETRATION W/FIRE-SMOKE SEAL DETAIL

NOT TO SCALE

- 1. PROVIDE UL LISTED FIRE/SMOKE PENETRATION ASSEMBLY IN ACCORDANCE INSTALLED.
- 2. FIRESTOPPING SHALL HAVE A RATING EQUAL TO OR GREATER THAN THE


GENERAL NOTES

- THE ELECTRICAL CONTRACTOR SHALL BE RESPONSIBLE FOR ALL WORK REQUIRED FOR A COMPLETE, FULLY OPERABLE INSTALLATION. ALL WORK TO BE DONE IN ACCORDANCE WITH THE LATEST APPROVED ISSUE OF THE NEC AND APPLICABLE LOCAL CODES.
- THIS IS AN EXISTING BUILDING. THE ELECTRICAL CONTRACTOR SHALL VISIT THE SITE PRIOR TO SUBMITTING A BID TO ASCERTAIN FIELD CONDITIONS AS THEY EXIST AND JUDGE THEIR EFFECT ON THE WORK TO BE DONE. NO ALLOWANCE WILL BE MADE FOR FAILURE TO VISIT THE JOB SITE AND MAKE THIS DETERMINATION.
- THE DRAWINGS SHOW THE GENERAL LAYOUT AND SOME OF THE DETAIL, BUT THEY DO NOT SHOW EVERY FITTING, BEND, ETC. ELECTRICAL CONTRACTOR SHALL PROVIDE ALL SUCH MATERIALS TO MAKE A COMPLETE INSTALLATION.
- 4. DO NOT SCALE DRAWINGS; ACTUAL FIELD MEASUREMENTS AND DIMENSIONS TAKE PRECEDENCE IN ALL CASES.
- ALL WORK SHALL BE DONE IN ACCORDANCE WITH THE STANDARD GENERAL CONDITIONS OF THE CONSTRUCTION CONTRACT, AIA DOCUMENT 201, LATEST EDITION.
- ELECTRICAL CONTRACTOR SHALL INSTALL ALL EQUIPMENT IN ACCORDANCE WITH MANUFACTURERS INSTRUCTIONS AND/OR REQUIREMENTS FOR PROPER OPERATION AND MAINTENANCE.
- ELECTRICAL CONTRACTOR SHALL GIVE OWNER SEVEN (7) DAYS ADVANCE NOTICE OF SHUTDOWNS. SHUTDOWNS TO BE KEPT TO A MINIMUM. AT NO TIME SHALL THE BUILDING/SPACE BE LEFT WITHOUT COMMERCIAL POWER IN FULL OPERATING ORDER.
- ELECTRICAL CONTRACTOR SHALL BE RESPONSIBLE FOR TESTING OF ALL PHASES OF THE WORK AND TO DEMONSTRATE TO OWNER THAT THE EQUIPMENT IS IN FULL OPERATING ORDER.
- 9. ELECTRICAL CONTRACTOR SHALL RESTORE ALL AREAS DISTURBED TO THEIR ORIGINAL CONDITION. ELECTRICAL CONTRACTOR IS RESPONSIBLE FOR ALL CUTTING, PATCHING, PAINTING, CLEAN-UP, ELECTRICAL DEBRIS REMOVAL AND GENERAL COORDINATION OF THE WORK EFFORT AS REQUIRED FOR THE INSTALLATION OF THE ELECTRICAL ITEMS OF WORK.
- 10. THE TERM "PROVIDE" SHALL MEAN TO FURNISH AND INSTALL IN COMPLETE WORKING ORDER.
- 11. THE SCOPE OF WORK IS AS SHOWN ON THE PLANS AND DETAILED IN THE SPECIFICATIONS.
- 12. ALL THE WIRE SIZES ARE BASED ON COPPER; ALUMINUM IS NOT TO BE USED.
- 13. ALL WIRING METHODS ARE TO BE IN ACCORDANCE WITH THE CURRENT ISSUE OF THE NATIONAL ELECTRICAL CODE, AND APPLICABLE LOCAL CODES. ALL WIRING IS TO BE IN CONDUIT, UNLESS SPECIFICALLY NOTED OTHERWISE. ALL WIRING IS TO BE CONCEALED.
- 14. PROVIDE INDEPENDENT SEISMIC SUPPORT OF ALL ELECTRICAL EQUIPMENT PER INTERNATIONAL BUILDING CODE.
- 15. ELECTRICAL CONTRACTOR SHALL SECURE ALL PERMITS AND PAY FOR ALL REQUIRED FEES.
- 16. ELECTRICAL CONTRACTOR SHALL WARRANT AND GUARANTEE ALL MATERIALS AND WORKMANSHIP FOR A PERIOD OF ONE (1) YEAR FROM THE DATE OF FINAL ACCEPTANCE BY THE OWNER.
- 17. ELECTRICAL CONTRACTOR SHALL PROVIDE PROOF OF LIABILITY AND PROPERTY INSURANCE TO THE OWNER. ALL DEDUCTIBLES SHALL BE PAID FOR BY THE ELECTRICAL CONTRACTOR IN THE EVENT OF A CLAIM.
- 18. PERSONNEL SAFETY IS OF PRIME IMPORTANCE. NO HAZARDOUS CONDITION MUST BE ALLOWED. EVERY CARE MUST BE TAKEN TO PROTECT CONSTRUCTION AND OTHER PERSONNEL. CLEANUP IS TO BE DONE ON A DAILY BASIS. ELECTRICAL CONTRACTOR
- 19. ELECTRICAL CONTRACTOR SHALL PROVIDE SHOP DRAWINGS FOR APPROVAL FOR ALL LIGHTING FIXTURES, PANELS, SWITCHES, RECEPTACLES, ETC.
- 20. ELECTRICAL CONTRACTOR TO VERIFY LIGHTING FIXTURE MOUNTING REQUIREMENTS FOR VARIOUS CEILING TYPES AND ORDER APPROPRIATE HARDWARE.
- 21. COORDINATE EXACT PLACEMENT OF EQUIPMENT WITH ELEVATOR AND MECHANICAL PLANS. MAKE FIELD ADJUSTMENTS AS REQUIRED TO AVOID CONFLICTS, VERIFY WITH OWNER.
- 22. ELECTRICAL CONTRACTOR TO COORDINATE WITH ELEVATOR INSTALLER AND MECHANICAL CONTRACTOR FOR ITEMS SUPPLIED BY THE MECHANICAL/OTHER DIVISIONS BUT INSTALLED BY THE ELECTRICAL CONTRACTOR. ELECTRICAL CONTRACTOR TO REVIEW ALL THE PLANS FOR THE PROJECT FOR ELECTRICAL WORK.
- 23. ELECTRICAL CONTRACTOR TO VERIFY ALL EQUIPMENT POWER NEEDS WITH THE ACTUAL SHOP DRAWINGS FOR THE EQUIPMENT TO BE USED, PRIOR TO STARTING ANY ELECTRICAL WORK.
- 24. SPECIFICATION SECTIONS, GENERAL CONDITIONS, SUPPLEMENTAL GENERAL CONDITIONS AND DRAWINGS ARE INTEGRAL PARTS OF CONTRACT DOCUMENTS.
- 25. THE DISPOSAL OF ALL UNUSED EXISTING ELECTRICAL EQUIPMENT REMOVED IS A PART OF THE SCOPE OF WORK. THE ELECTRICAL CONTRACTOR SHALL DISPOSE OF ALL SUCH EQUIPMENT, INCLUDING HAZARDOUS PCB CONTAINING BALLASTS, IN A MANNER CONSISTENT WITH STATE OF CT. DEPARTMENT OF ENVIRONMENTAL PROTECTION REGULATIONS, CURRENT ISSUE.
- 26. SHARED NEUTRALS ARE NOT TO BE USED. PROVIDE SEPARATE NEUTRALS FOR ALL CIRCUITS.
- 27. PRIOR TO SUBMISSION OF BIDS GIVE WRITTEN NOTICE TO ARCHITECT AND ENGINEER OF ANY MATERIAL OR APPARATUS THAT IS INADEQUATE, UNSUITABLE FOR THE USE, IN VIOLATION OF LAWS, ORDINANCES, RULES, CODES OR ANY REGULATIONS OF AUTHORITIES HAVING JURISDICTION OR ANY NECESSARY ITEMS OF WORK THAT HAS BEEN OMITTED. CONTRACTOR AFFIRMS THAT IN ABSENT OF SUCH NOTICE, ALL SYSTEMS WILL FUNCTION SATISFACTORILY WITHOUT ADDITIONAL EXTRA COMPENSATION.
- 28. ALL PART NUMBERS ARE PROVIDED FOR THE CONVENIENCE OF THE CONTRACTOR. THEY ARE NOT TO BE CONSIDERED THE COMPLETE SPECIFICATION OF THE PRODUCT. THE PART NUMBER AND DESCRIPTION WILL BE THE COMPLETE SPECIFICATION. IN THE EVENT OF A DISCREPANCY BETWEEN THE TWO (2), THE MORE STRINGENT, MORE COSTLY FEATURE/PERFORMANCE WILL BE REQUIRED.
- 29. FOR ALL GRADE LEVEL HVAC EQUIPMENT, THE ELECTRICAL CONTRACTOR SHALL SUPPLY A GFCI WP, 20A RECEPTACLE FOR
- EQUIPMENT SERVICING. ALL DISCONNECT SWITCHES ARE TO BE HEAVY DUTY, FUSED, WEATHER PROOF (WP) DEVICES.
- 30. NO LOW VOLTAGE WIRING SHALL BE PERMITTED IN THE SAME RACEWAY AS POWER WIRING.
- 31. FURNISH & INSTALL GFCI RECEPTACLES IN ALL WET LOCATIONS.


TO REMOVE AND DISPOSE OF REFUSE FROM SITE.

- 32. PROVIDE PULL STRINGS IN ALL EMPTY RACEWAYS.
- 33. CIRCUIT NUMBERS ARE INDICATED FOR INTENT ONLY. THE ELECTRICAL CONTRACTOR SHALL ADJUST ACCORDINGLY IN THE FIELD, TO BALANCE CIRCUITS EVENLY ON ALL PHASES.
- 34. MINIMUM CONDUCTOR SIZE, UNLESS OTHERWISE NOTED SHALL BE #12 FOR ALL BRANCH CIRCUIT RUNS UP TO THE FIRST OUTLET; OVER 100 FEET, #10; OVER 150 FEET, #8; INCREASE CONDUIT SIZE TO SUIT.
- 35. ELECTRICAL CONTRACTOR TO VERIFY LOADS, SETTINGS, OVERCURRENT PROTECTION, ETC. TO INSURE COMPATIBILITY OF
- EQUIPMENT.
- 36. NO PENETRATIONS ARE ALLOWED INTO STAIR ENCLOSURES EXCEPT AS REQUIRED FOR SERVICES UTILIZED IN THE STAIR.
- 37. REPAIR AND REPLACE AT NO COST TO OWNER ALL EQUIPMENT AND MATERIALS DAMAGED DURING CONSTRUCTION. 38. ELECTRICAL CONTRACTOR SHALL COORDINATE ALL DEMOLITION WITH BASE BUILDING ELECTRICIAN.
- 39. PRODUCTS SHALL NOT BE INSTALLED IN PROMINENT LOCATIONS UNLESS NO ALTERNATIVE EXISTS. ITEMS SHALL BE CENTERED ON WALL OR CEILING TREATMENT AND ON ONE ANOTHER AS APPLICABLE. THIS INCLUDES BUT IS NOT LIMITED TO ACCESS PANELS, LIGHTING FIXTURES, SWITCHES, THERMOSTATS, FIRE ALARM DEVICES, EXIT SIGNS, ELECTRICAL PANELS, AND ANNUNCIATOR PANELS OF ANY KIND.
- 40. ELECTRICAL CONDUITS & BOXES SHALL BE CONCEALED IN WALLS OR ABOVE CEILINGS WHEREVER POSSIBLE.
- 41. INSTALLATIONS ON EXISTING WALLS SHALL BE RUN WITH SURFACE RACEWAY PAINTED TO MATCH WALL FINISH AND SURFACE
- BOXES. USE METAL WIREMOLD FOR INSTALLATIONS WITHIN OCCUPIED AREAS. 42. POWER RECEPTACLES COVER PLATES SHALL BE LABELED WITH DESIGNATED PANEL AND CIRCUIT NUMBER SERVING UNIT.



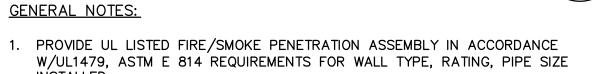

WALL/FLOOR BEING PENETRATED - SEE PROJECT MANUAL. REFER TO DRAWINGS FOR WALL/FLOOR RATINGS AND LOCATIONS.

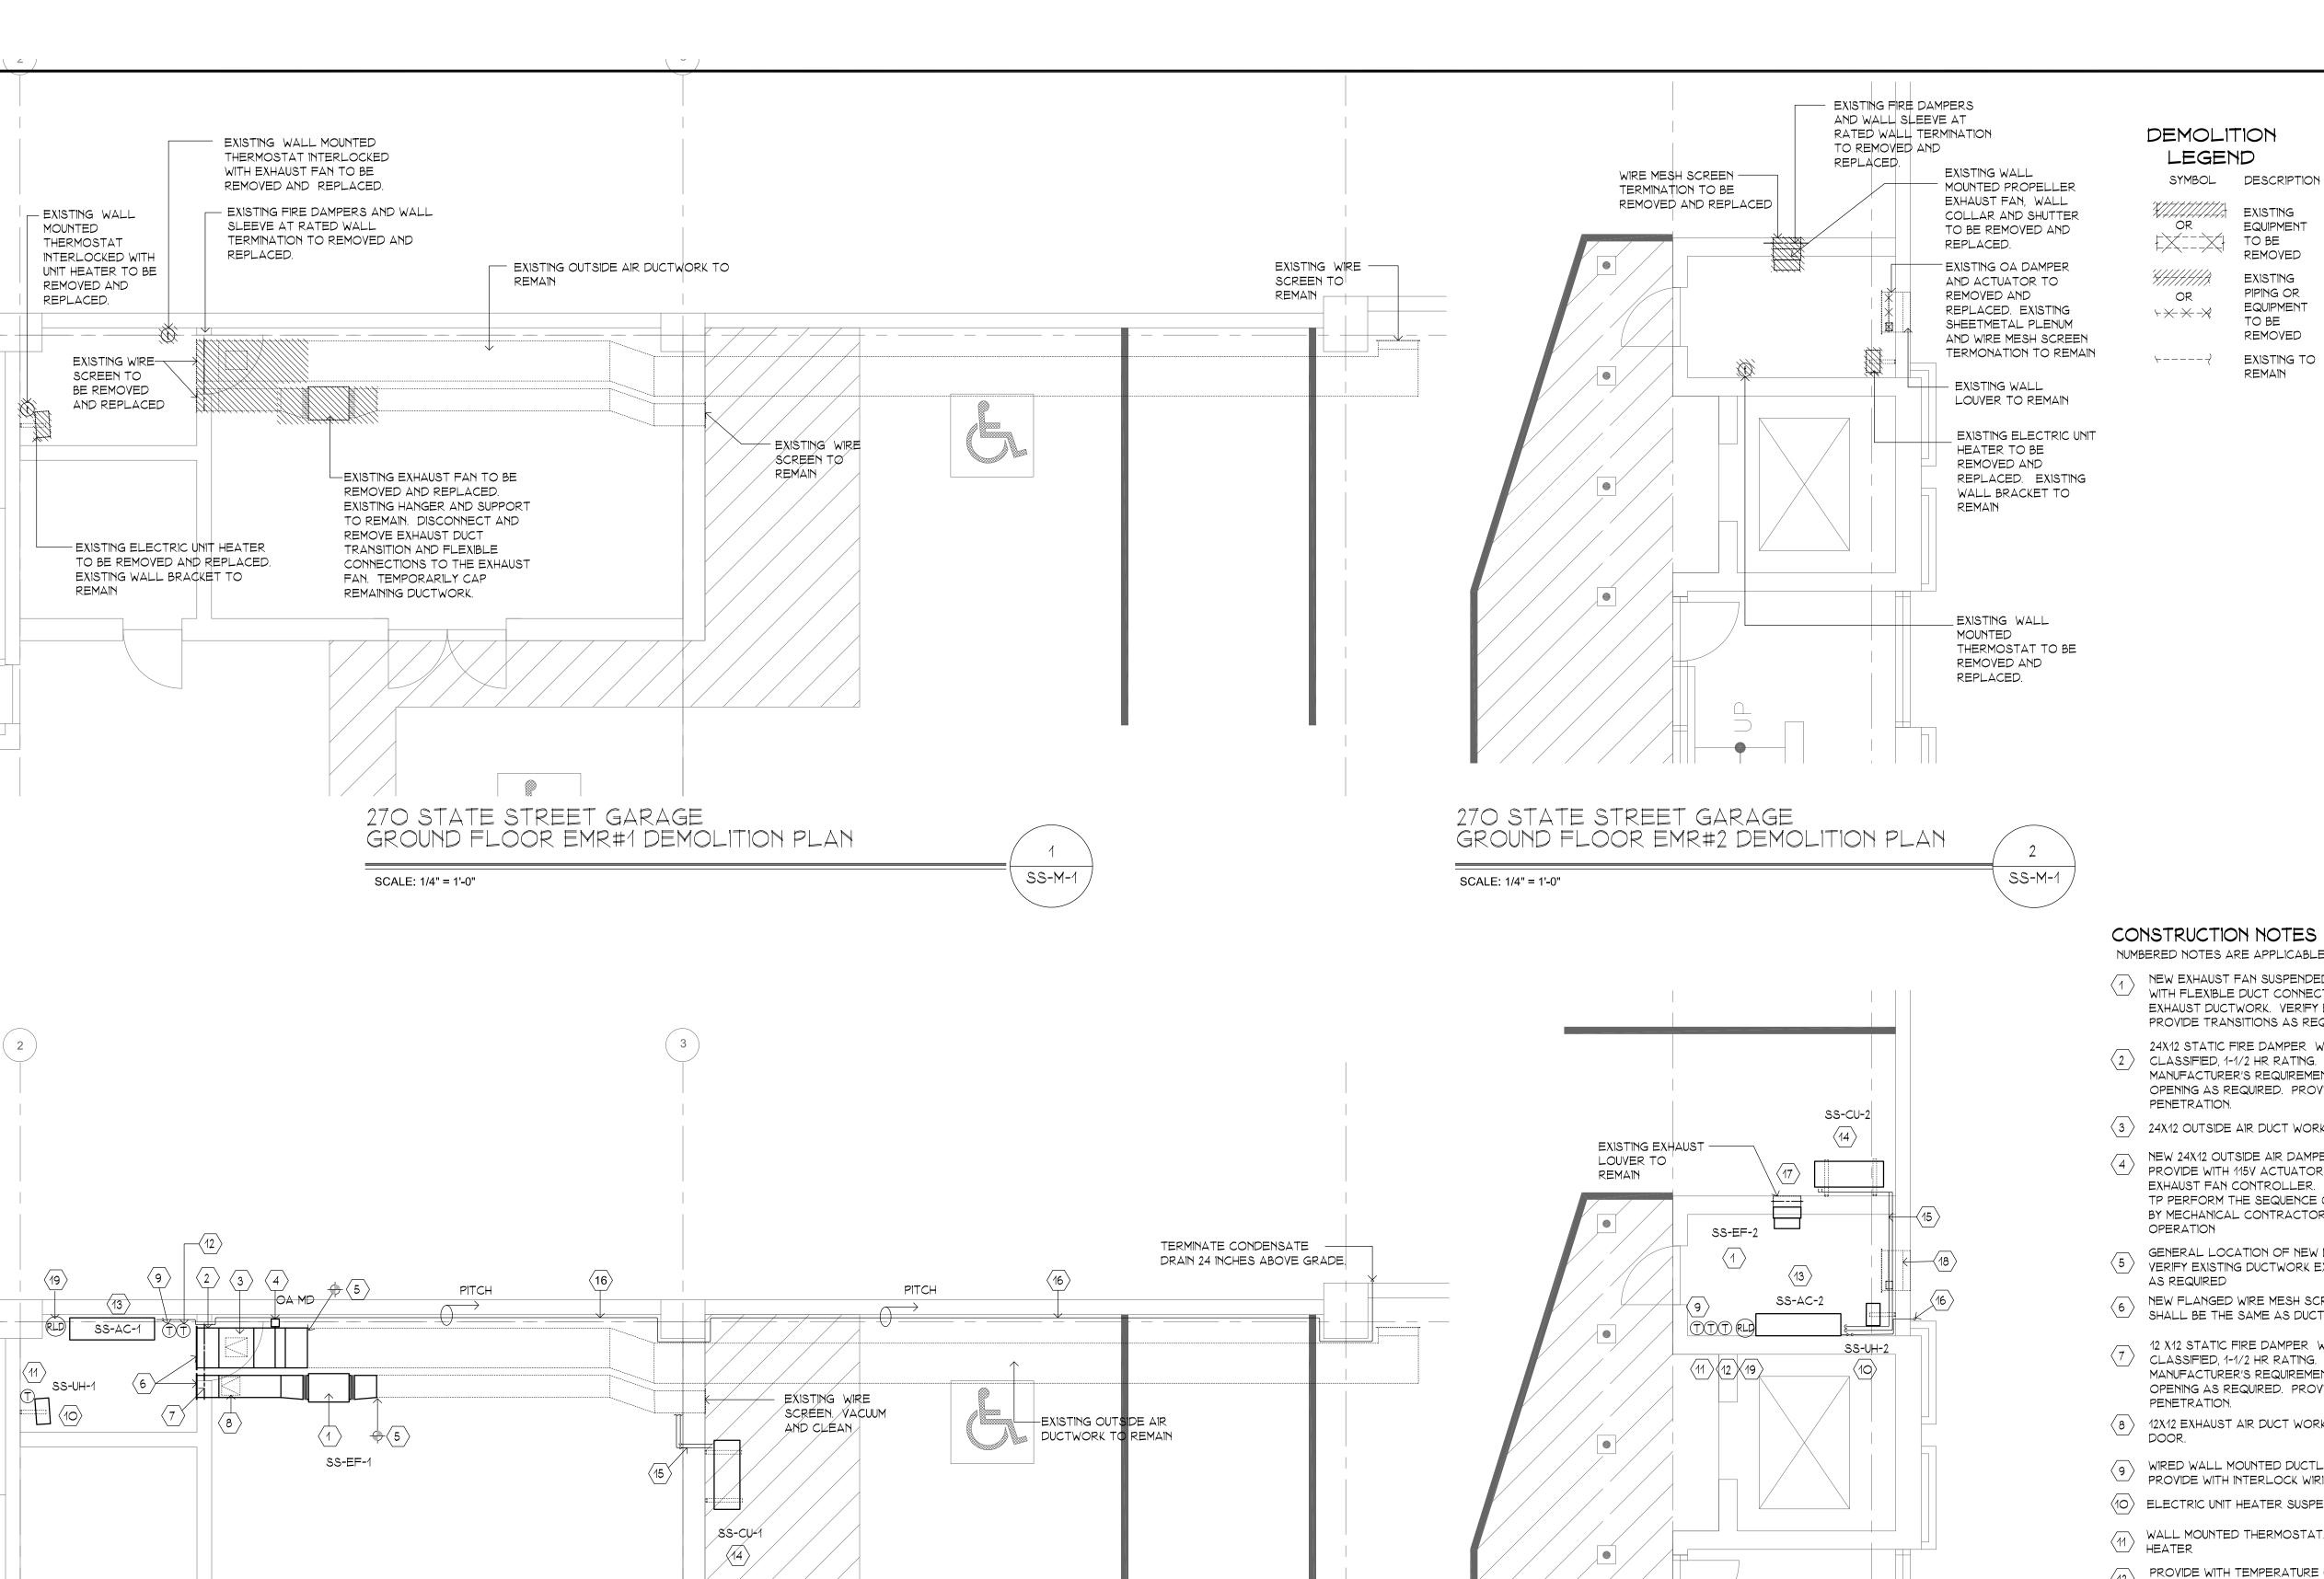

CONSTRUCTION NOTES NUMBERED NOTES ARE APPLICABLE TO DRAWING SHEET ONLY

EQUIPMENT

REMOVED

EXISTING

PIPING OR

TO BE

EQUIPMENT

REMOVED

EXISTING TO

NEW EXHAUST FAN SUSPENDED FROM EXISTING BRACKET. PROVIDE WITH FLEXIBLE DUCT CONNECTIONS CONNECT TO EXISTING EXHAUST DUCTWORK. VERIFY EXISTING DUCTWORK SIZE IN FIELD. PROVIDE TRANSITIONS AS REQUIRED

24X12 STATIC FIRE DAMPER WITH INTEGRAL SLEEVE, UL 555 CLASSIFIED, 1-1/2 HR RATING. INSTALL IN ACCORDANCE WITH MANUFACTURER'S REQUIREMENTS. CUT, PATCH AND REPAIR WALL OPENING AS REQUIRED. PROVIDE FIRESTOP AT WALL

(3) 24X12 OUTSIDE AIR DUCT WORK. PROVIDE WITH 12X12 ACCESS DOOR.

NEW 24X12 OUTSIDE AIR DAMPER WITH MOTORIZED DAMPER. PROVIDE WITH 115Y ACTUATOR. INTERLOCK ACTUATOR WITH EXHAUST FAN CONTROLLER. ALL INTERLOCK DEVICES AND WIRING TP PERFORM THE SEQUENCE OF OPERATION SHALL BE PROVIDED BY MECHANICAL CONTRACTOR. REFER TO SEQUENCE OF

GENERAL LOCATION OF NEW DUCTWORK CONNECTION TO EXISTING. $\langle 5 \rangle$ VERIFY EXISTING DUCTWORK EXACT DIMENSION. PROVIDE TRANSITION

6 NEW FLANGED WIRE MESH SCREEN AT WALL TERMINATION. SIZE SHALL BE THE SAME AS DUCTWORK SIZE.

12 X12 STATIC FIRE DAMPER WITH INTEGRAL SLEEVE, UL 555 CLASSIFIED, 1-1/2 HR RATING. INSTALL IN ACCORDANCE WITH MANUFACTURER'S REQUIREMENTS. CUT, PATCH AND REPAIR WALL OPENING AS REQUIRED. PROVIDE FIRESTOP AT WALL

(8) 12X12 EXHAUST AIR DUCT WORK. PROVIDE WITH 10X10 ACCESS

WIRED WALL MOUNTED DUCTLESS SPLIT SYSTEM CONTROLLER. PROVIDE WITH INTERLOCK WIRING

(10) ELECTRIC UNIT HEATER SUSPENDED FROM EXISTING BRACKET.

WALL MOUNTED THERMOSTAT. INTERLOCK WITH ELECTRIC UNIT HEATER

PROVIDE WITH TEMPERATURE CONTROLLER LOREN COOK MODEL VFTC AND VARIFLOW AIR BALANCE KIT (VFABK), OR EQUIVALENT PROVIDE VFABK WITH 24-YOLT TRANSFORMER. CONTROLLER WILL BE INTERLOCKED WITH THE EXHAUST FAN AND THE OA MOTORIZED

DAMPER. PROVIDE ALL REQUIRED DEVICES AND INTERLOCK WIRINGS

DUCTLESS SPLIT WALL MOUNTED INDOOR UNIT. BOTTOM OF UNIT SHALL BE AT 8'-O" AFF MINIMUM TO CLEAR EXISTING ELECTRICAL CONDUIT. PROVIDE WITH WALL BRACKET. INSTALL IN ACCORDANCE WITH THE MANUFACTURER'S INSTALLATION AND CLEARANCE REQUIREMENTS.

SIDEWALL MOUNTED CONDENSING UNIT. PROVIDE WITH MOUNTING BRACKET SUITED FOR THE NEW CONDENSING UNIT SIZE AND WEIGHT. MOUNT TOP ELEVATION OF CONDENSING UNIT 6 INCHES BELOW FIRE PROTECTION PIPING. COORDINATE HEIGHT OF MOUNTING BRACKET IN

270 STATE STREET GARAGE

GROUND FLOOR EMR#2 PLAN

SCALE: 1/4" = 1'-0"

INSULATED LIQUID AND GAS REFRIGERATION PIPING FROM INDOOR UNIT TO OUTDOOR UNIT. PROVIDE FIRESTOP CAULKING AT RATED WALL PENETRATION. COORDINATE ROUTING IN FIELD.

SS-M-1

GENERAL LOCATION OF CONDENSATE DRAIN PIPING FROM INDOOR UNIT ROUTED ALONG WALL. CONTRACTOR TO PROVIDE THE REQUIRED PITCH FOR GRAVITY DRAIN CONNECTION. COORDINATE IN FIELD. CONDENSATE DRAIN PIPING SHALL BE BE PITCHED TOWARDS THE DRAIN TERMINATION. COORDINATE ROUTING IN FIELD.

14 X14 STATIC FIRE DAMPER WITH INTEGRAL SLEEVE, UL 555 CLASSIFIED, 1-1/2 HR RATING. INSTALL IN ACCORDANCE WITH MANUFACTURER'S REQUIREMENTS. CUT , PATCH AND REPAIR WALL OPENING AS REQUIRED. PROVIDE FIRESTOP AT WALL PENETRATION.

EXISTING INTAKE LOUVER TO REMAIN. PROVIDE NEW MOTORIZED DAMPER AND ACTUATOR. COORDINATE EXACT SIZE IN FIELD

(19) WALL MOUNTED REFRIGERANT LEAK DETECTOR. MOUNT AT 9" AFF. INTERLOCK WITH EXHAUST FAN , OA AIR DAMPER AND ELECTRIC UNIT HEATER. REFER TO 23 O9 26 FOR SEQUENCE OF OPERATION

	L LEGEND L SYMBOLS ARE USED)
	REFERENCE, NUMBER INDICATES NOTE
>	EXISTING PIPING OR EQUIPMENT
}	EXISTING PIPING OR EQUIPMENT
	FLEXIBLE DUCT CONNECTION
•	POINT OF CONNECTION
	TRANSITION
MD	MOTORIZED DAMPER
FD	FIRE DAMPER
FD/AD	FIRE DAMPER WITH ACCESS DOOR
T	THERMOSTAT/SENSOR
<u> </u>	PIPE ELBOW, TURNED DOWN
	PIPE COUPLING (JOINT)
RLD	REFRIGERANT LEAK DETECTOR

ABBREVIATIONS (NOT ALL SYMBOLS ARE USED)

AC- # INDOOR AIR CONDITIONING UNIT ACCESS DOOR

ABOVE FINISHED FLOOR

CAP CAPACITY CFM CUBIC FEET PER MINUTE

CABINET UNIT HEATER DB DRY BULB

DD DIRECT DRIVE EF-# EXHAUST FAN

EAT ENTERING AIR TEMPERATURE EER ENERGY EFFICIENCY RATIO

EMR ELEVATOR MACHINE ROOM EUH-# ELECTRIC UNIT HEATER

EXISTING EXHAUST

DEGREES FAHRENHEIT FIRE DAMPER

FULL LOAD AMPERES

GENERAL CONTRACTOR

HORSEPOWER

HTG HEATING INCHES

KILOWATT LEAVING AIR TEMPERATURE

1000 BTU'S MINIMUM CIRCUIT AMPACITY

MOTORIZED DAMPER MD

MAXIMUM FUSE SIZE

MINIMUM

OUTSIDE AIR OAT

OUTDOOR AIR TEMPERATURE

PHASE RM ROOM

REVOLUTIONS PER MINUTE

STATIC PRESSURE

SQ FT SQUARE FOOT (AREA) SINGLE POLE SWITCH

W/THERMAL OVERLOAD SIDE WALL REGISTER

THERMOSTAT TEMPERATURE DIFFERENCE TD

WEIGHT (LBS)

TEMP TEMPERATURE TOT

TYP TYPICAL

W/

WET BULB WIRE MESH SCREEN

WITH

1. THE INTENT OF THESE CONTRACT DOCUMENTS IS FOR THE CONTRACTOR TO FURNISH AND INSTALL COMPLETE HVAC SYSTEMS. ALL SYSTEMS SHALL BE COMPLETE IN ALL RESPECTS. OPERATING, TESTED, ADJUSTED, APPROVED BY THE AUTHORITIES HAVING JURISDICTION AND READY FOR BENEFICIAL USE BY THE

OWNER. 2. THE CONTRACTOR SHALL OBTAIN AND REVIEW ALL CONTRACT DOCUMENTS, INCLUDING PROJECT MANUAL PLANS AND SPECIFICATIONS OF ALL TRADES BEFORE SUBMITTING BID. REFER TO SPECIFICATIONS, PROJECT MANUAL AND PLANS, INCLUDING ALL EQUIPMENT SCHEDULES FOR MECHANICAL AND ELECTRICAL

BUILDING PRIOR TO SUBMITTING BID. 3. ALL OF THE CONTRACT DRAWINGS AND SPECIFICATIONS ARE COMPLEMENTARY TO FORM A TOTAL DESIGN PACKAGE. IT IS THE RESPONSIBILITY OF THE GENERAL CONTRACTOR/CONSTRUCTION MANAGER TO DETERMINE WHICH TRADE CONTRACTOR

4. ALL WORK AND ACTION DEPICTED AND DESCRIBED IN CONTRACT DOCUMENTS SHALL BE PERFORMED BY THE CONTRACTOR UNLESS SPECIFICALLY NOTED OTHERWISE.

5. THE DRAWINGS ARE DIAGRAMMATIC AND INDICATE THE GENERAL ARRANGEMENT OF SYSTEMS AND WORK INCLUDED IN THE CONTRACT. THE CONTRACTOR SHALL COORDINATE LOCATIONS OF EQUIPMENT WITH ALL TRADES BEFORE STARTING CONSTRUCTION. ANY MODIFICATIONS TO THE EQUIPMENT LAYOUT REQUIRED FOR INSTALLATION ARE TO BE PERFORMED AT NO ADDITIONAL COST TO THE OWNER.

6. WHEN CONFLICTS OCCUR BETWEEN THE DRAWINGS AND/OR SPECIFICATIONS IT SHALL BE BROUGHT TO THE ATTENTION OF THE ENGINEER. THE CONTRACTOR SHALL CARRY AS PART OF THE BID THE LARGER QUANTITY AND/OR MORE EXPENSIVE ITEM(S).

7. ALL WORK SHALL BE PERFORMED IN ACCORDANCE WITH THE REQUIREMENTS OF THE CONTRACT GENERAL CONDITIONS AND WITH THE PROVISIONS OF ALL APPLICABLE LOCAL, STATE, AND FEDERAL CODES AND LAWS.

8. ALL WORK AND ACTION DEPICTED AND DESCRIBED SHALL BE PERFORMED BY THE CONTRACTOR. ITEMS AND SERVICES NOT SHOWN ON DRAWINGS OR SPECIFICATIONS BUT ARE REQUIRED TO RENDER THE WORK COMPLETE AND READY FOR OPERATION, SHAL BE PROVIDED WITHOUT ADDITIONAL COST.

9. OBTAIN AND PAY FOR ALL REQUIRED PERMITS AND INSPECTIONS. 10. PROVIDE SUPPORT/BRACING OF EQUIPMENT AND

BUILDING SERVICES AS REQUIRED BY THE BUILDING REPAIR AND REPLACE AT NO COST TO OWNER ALL EQUIPMENT AND MATERIALS DAMAGED DURING

12. ALL EQUIPMENT, MATERIALS AND RELATED SYSTEMS COMPONENTS SHALL BE NEW UNLESS SPECIFICALLY NOTED OTHERWISE.

13. ALL EQUIPMENT, PIPING, DUCTWORK SHALL BE SUPPORTED AS DETAILED. SPECIFIED AND REQUIRED TO PROVIDE A VIBRATION FREE INSTALLATION. 14. CONTRACTORS SHALL PROVIDE ALL REQUIRED

CONSTRUCTION.

EQUIPMENT.

PENETRATING WALLS OR FLOOR SLABS WITH FIRE STOPPING SEALANT WHERE REQUIRED. PROVIDE VIBRATION ISOLATION FOR ALL MECHANICAL

SLEEVES AND SEALS FOR PIPES OR CONDUIT

16. INSTALL COMPLETE OPERATING SYSTEMS. PROVIDE ALL COMPONENTS, DEVICES, CONTROLS, RELAYS, TRANSFORMERS, ETC., WHETHER INDICATED OR NOT, FOR COMPLETE SYSTEMS AS INTENDED BY THE

CONSTRUCTION DOCUMENTS. 17. ALL PENETRATIONS THRU RATED WALLS, FLOORS & CEILINGS SHALL BE SEALED USING U.L. LISTED

METHODS APPROPRIATE FOR INDICATED RATING 18. PROVIDE ACCESS DOORS/PANELS FOR INSTALLATION IN WALLS AND/OR CEILINGS, WHERE REQUIRED, TO

SERVICE FIRE DAMPER. 19. PROVIDE ACCESS DOORS/PANELS FOR INSTALLATION

WALLS AND/OR CEILINGS, WHERE REQUIRED, TO SERVICE FIRE DAMPER.

ALTERATION WORK AND DEMOLITION

1. THE EXISTING CONDITIONS REPRESENTED HEREON AR BASED ON GENERAL LOCATIONS OF EXISTING COMPONENTS IN THE FIELD AND ARE SHOWN ON THIS DRAWING FOR CONTRACTORS REFERENCE ONLY. ACTUAL LOCATION AND SIZE OF EQUIPMENT AND DUCTWORK AND EXTENT OF DUCTWORK ROUTING, PIPING AND EXTENT OF PIPING LENGTH AND ROUTING AND UTILITIES MAY VARY IN FIELD. MECHANICAL CONTRACTOR SHALL VERIFY LOCATIONS IN FIELD

AND MAKE ALLOWANCE IN BID FOR LOCATIONS AND

ARRANGEMENTS OTHER THAN SHOWN. THE DEMOLITION NOTES ARE FOR DESCRIPTIVE GUIDE ONLY. THE CONTRACTOR SHALL BE RESPONSIBLE FOR THE REMOVAL OF ALL ITEMS WHETHER OR NOT INDICATED AND/ OR NOTED ON THE DRAWINGS. INCLUSION OF THESE EXISTING CONDITIONS HEREON SHALL IN NO WAY ALLEVIATE THE CONTRACTOR(S) OF HIS RESPONSIBILITY TO VISIT THE SITE TO VERIFY

REMOVE, MODIFY AND REPLACE EXISTING SYSTEMS A REQUIRED FOR INSTALLATION OF NEW HVAC SYSTEMS 4. IT IS NOT THE INTENT OF THESE DRAWINGS TO SHOW EVERY PIECE OF EQUIPMENT, PIPING OR CONDUIT TO BE REMOVED. EQUIPMENT NOT BEING USED SHALL BE REMOVED INCLUDING ALL ASSOCIATED HANGERS,

SUPPORTS, PIPES, DUCTS, CONDUITS, WIRES AND

ALL EXISTING CONDITIONS.

5. ALL WASTE MATERIALS AND EQUIPMENT SHALL BE REMOVED FROM SITE AND SHALL BE LEGALLY DISPOSED BY THE CONTRACTOR.

CONTROLS BACK TO THE POINT OF ORIGIN.

6. NO EQUIPMENT, PIPING OR CONDUIT SHALL BE ABANDONED IN PLACE UNLESS SPECIFICALLY NOTED.

7 NO WORK SHALL BE LEFT INCOMPLETE NOR ANY HAZARDOUS SITUATIONS CREATED WHICH WILL AFFECT THE LIFE OR SAFETY OF THE PUBLIC AND/OR BUILDING OCCUPANTS. AT NO TIME SHALL THE WORK INTERFERE WITH OR CUTOFF ANY OF THE EXISTING SERVICES WITHOUT THE OWNER'S WRITTEN

PERMISSION. 8. COORDINATE SHUTDOWN OF EXISTING SERVICES WITH OWNER'S MAINTENANCE PERSONNEL. NO WORK SHALL TAKE PLACE UNTIL DOING SO.

9. THE CONTRACTOR IS RESPONSIBLE FOR

AND THE WORK OF OTHER TRADES.

CONSTRUCTION DOCUMENTS.

COORDINATING HIS WORK WITH ALL TRADES. 10. PIPING AND DUCT WORK LAYOUTS AS INDICATED ON THE DRAWINGS ARE DIAGRAMATIC; PROVIDE ADDITIONAL TRANSITIONS AND OFFSETS AS REQUIRED SECOND LEVEL EMR FOR COORDINATION WITH BUILDING CONSTRUCTION

11. PROVIDE FIRE DAMPERS AT DUCT PENETRATIONS OF FIRE RATED PARTITIONS.

12. MAINTAIN MANUFACTURER'S RECOMMENDED MINIMUM CLEARANCES FOR INSTALLATION OF EQUIPMENT.

13 INSTALL COMPLETE OPERATING SYSTEMS. PROVIDE ALL COMPONENTS, DEVICES, CONTROLS, RELAYS, TRANSFORMERS, ETC., WHETHER INDICATED OR NOT, FOR COMPLETE SYSTEMS AS INTENDED BY THE

14 THE TEMPERATURE CONTROL SYSTEM SHALL BE COMPLETE IN ALL REGARDS, TESTED AND CAPABLE OF ACHIEVING THE SEQUENCES OF OPERATION. ALL DEVICES SHALL BE UNDER SYSTEM CONTROL. ALL SPACES SHALL BE THERMOSTATICALLY CONTROLLED WHETHER OR NOT A THERMOSTAT, SENSOR OR CONTROLLER IS INDICATED.

INFORMATION. CONTRACTOR SHALL WALK THROUGH IS RESPONSIBLE FOR VARIOUS PORTIONS OF THE

X

H

NO. DATE BY

REVISIONS DRAWING TITLE 270 STATE STREET GARAGE GROUND FLOOR AND


RAWING NO.

PLANS

SS-M-1SCALE: AS NOTED

DATE: JULY 2025 PROJECT NO. 20-20176.00-2 IHPA NO. 21-011 DESIGN | DRAWN | CH'KD AMG AMG RRB

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2. PROVIDE WITH WALL MOUNTED

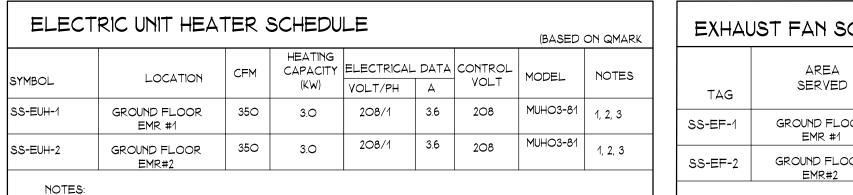3. PROVIDE DISCONNECT SWITCH

THERMOSTAT

270 STATE STREET GARAGE

GROUND FLOOR EMR#1 PLAN

WXHXD

INCH

SCALE: 1/4" = 1'-0"

SCHEDULE FOR DUCTLESS SPLIT SYSTEM

PKA-A12LA | 35.4 X 11.78 X 9.35

2 MANUFACTURER PROVIDED WALL MOUNTED WIRED CONTROLLER

MODEL

WALL MOUNTED

PKA-A12LA

INDOOR UNIT

TAG | AREA SERVED |

GROUND

FLOOR EMR#1

SS-AC-2 FLOOR EMR#2 WALL MOUNTED

1 PROVIDE DISCONNECT SWITCH

PROVIDE WITH AUTOMATIC RESET LINEAR THERMAL

OVER ENTIRE LENGTH OF ELEMENTS

CUT-OUT, CAPILLARY TYPE TO PROVIDE PROTECTION

SS=M=1

WEIGHT CAPACITY (BTU/HR)

PERFORMANCE

28 | SS-CU-2 | PUY-AK12 | 31.8 X 24.8 X 11.8 | 92 | 4,400 | 12,000 | 17.1 | 21.1 | 208-230/1/60 | 16 | 20 | 1 / 4 / 3 /8 | R454B | 1 TO 5

5 SIDEWALL MOUNTED OUTDOOR UNIT PROVIDE WITH WALL BRACKET

PROVIDE LOW AMBIENT WIND BAFFLE FOR COOLING OPERATION DOWN TO O DEG F

PUY-AK12 | 31.8 X 24.8 X 11.8 | 92 | 4,400 | 12,000 | 17.1 | 21.1 | 208-230/1/60 | 16 | 20 | 1 / 4 / 3 /8 | R454B | 1 TO 5

4 INDOOR UNIT TO RECEIVE POWER FROM OUTDOOR UNIT THROUGH FIELD SUPPLIED INTERCONNECTING WIRING

| (LBS) | MINIMUM | RATED | EER | SEER |

OUTDOOR UNIT

TAG MODEL

EXHAUST FAN SCHEDULE (BASED ON LOREN COOK) DAMPER STATIC | FAN | ELECTRICAL | MOTOR PRESS | RPM | VOLTS/ ACTUATOR SERVED CFM | (IN. WG.) | ' NOTES VOLTAGE PH | HP ENCLOSURE RPM | MODEL 115 V BACKFRAFT | 1 3 4 GROUND FLOOR IN-LINE | 800 | 0.20 | 1623 | 115/1 | 1/4 | OPEN-EC | 1725 | 100SQND-VF | | PROPELLER | 1200 | 0.125 | 1463 | 115/1 | 1/4 | OPEN-EC | 1725 | 12XWPD-EC | 115 V SHUTTER | 2, 3, 4 GROUND FLOOR

(BASIS OF DESIGN: TRANE/ MITSUBISHI)

REFRIGERATION PIPING (IN)

NOTES: 1. DIRECT DRIVE IN-LINE EXHAUST FAN, PROVIDE WITH: DISCONNECT SWITCH, FAN HOUSING WITH 0.5-INCH THICK INSULATION, EC MOTOR, MOTORIZED BACKDRAFT DAMPER.

ELECTRICAL

V/PH/HZ MCA RFS LIQUID / VAPOR

2. DIRECT DRIVE PROPELLER FAN, PROVIDE WITH: DISCONNECT SWITCH, EC MOTOR, MOTORIZED SHUTTER AND WALL COLLAR 3. PROVIDE WITH TEMPERATURE CONTROLLER LOREN COOK MODEL VFTC AND VARIFLOW AIR BALANCE KIT (VFABK). PROVIDE VFABK WITH 24-VOLT TRANSFORMER. INTERLOCK WITH THE EXHAUST FAN AND THE OA MOTORIZED DAMPER. CONTRACTOR TO PROVIDE ENCLOSURE AND ALL REQUIRED DEVICES AND INTERLOCK WIRINGS.

4 INTERLOCK WITH CONTRACTOR PROVIDED REFRIGERANT LEAK DETECTOR. LEAK DETECTOR SHALL BE EQUIVALENT TO BACHARACH MGS-450 SERIES. COORDINATE EXACT LOCATION IN FIELD.


DISCONNECTED BY ELECTRICAL CONTRACTOR. REMOVE ASSOCIATED WIRING AND CONDUIT BACK TO SOURCE.

 $\langle 6 \rangle$ APPROXIMATE LOCATION OF EXISTING ELECTRICAL PANEL RATED 200A, 120/208V-3PH, 4 WIRE SERVING ELEVATOR CAB LIGHTING, M.R. LIGHTING, POWER RECEPTACLE AND ELEVATOR CONTROLLERS. REFER TO

DEMOLITION ABBREVIATION

- ER EXISTING TO REMAIN (UNLESS OTHERWISE INDICATED, SHOWN FOR REFERENCE PURPOSE ONLY).
 - AND CONDUIT BACK TO SOURCE
 - RR EXISTING TO BE REMOVED AND RELOCATED. CONTRACTOR TO EXTEND ASSOCIATED WIRING AND CONDUIT TO NEW LOCATION.

- UNLESS OTHERWISE INDICATED, THE ELECTRICAL CONTRACTOR SHALL
- 2. NO EQUIPMENT OR DEVICES THAT HAVE BEEN DISCONNECTED AND/OR ABANDONED SHALL REMAIN.
- FAMILIAR WITH THE EXISTING SYSTEMS AND CONDITIONS IN AREAS OF RENOVATION.
- SHALL BE KEPT IN OPERATION BY PROVIDING TEMPORARY CONNECTIONS AS REQUIRED UNTIL NEW SYSTEMS ARE INSTALLED AND OPERATIONAL.
- 5. THE ELECTRICAL CONTRACTOR SHALL COORDINATE WITH THE OWNER, CM, AND/OR GENERAL CONTRACTOR ANY AND ALL PHASING OF THE MECHANICAL DEMOLITION WORK IN ORDER TO SATISFY THE CONSTRUCTION SCHEDULE AND OWNER'S OCCUPANCY REQUIREMENTS.
- DEMOLITION DRAWINGS AS PART OF THIS CONTRACT FOR ADDITIONAL INFORMATION AND REQUIREMENTS.
- 8. ALL SERVICE INTERRUPTIONS SHALL BE COORDINATED AND APPROVED WITH
- 9. THE ELECTRICAL CONTRACTOR SHALL COORDINATE HIS DEMOLITION WORK
- ASSOCIATED CONDUIT, WIRE & BOXES ARE TO BE REMOVED AND DISPOSED OF UNLESS SPECIFICALLY NOTED OTHERWISE.
- 11. ALL MATERIALS BEING REMOVED SHALL BE HANDLED IN A MANNER COMPLYING WITH ALL PERTINENT LAWS, CODES AND ENVIRONMENTAL
- 12. ALL REMOVED COMPONENTS SHALL BE LEGALLY DISPOSED OF BY CONTRACTOR UNLESS SPECIFICALLY NOTED OTHERWISE.
- 13. WHERE EXISTING DEVICES ARE REMOVED & NO NEW DEVICES ARE INSTALLED IN THE SAME LOCATION, REMOVE ALL WIRING FROM BOX & PROVIDE PROPERLY SIZED BLANK COVER PLATE.
- COORDINATE AND FIELD VERIFY IF BRANCH CIRCUIT FEEDS THROUGH TO EQUIPMENT/DEVICES TO REMAIN. BRANCH CIRCUITS SHALL BE SPLICED OR RELOCATED TO MAINTAIN CONTINUATION OF SERVICES.

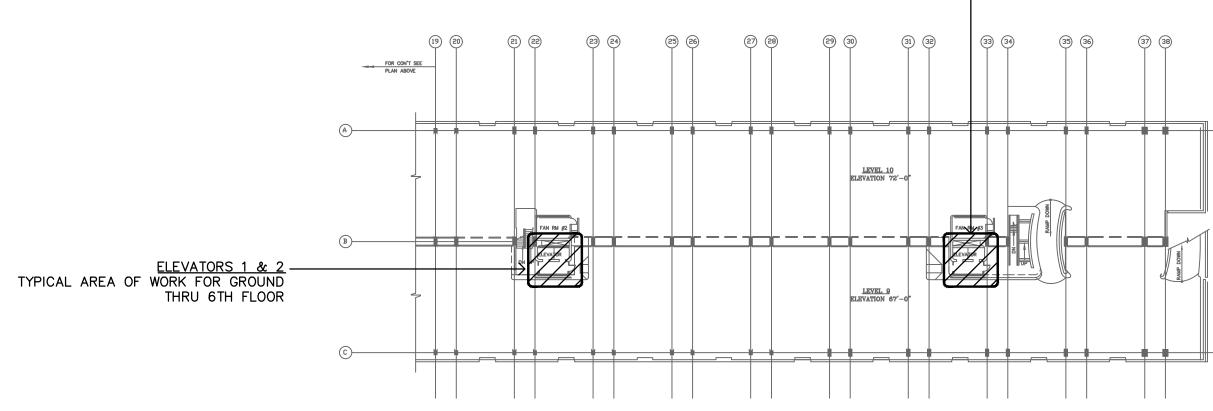

OVERALL KEY PLAN

NOT TO SCALE

DEMOLITION KEY NOTES

(1) APPROXIMATE LOCATION OF EXISTING ELEVATOR MOTOR TO BE DISCONNECTED BY ELECTRICAL CONTRACTOR. REMOVE ASSOCIATED WIRING AND CONDUIT BACK TO DISCONNECT SERVING ELEVATOR.

2 APPROXIMATE LOCATION OF EXISTING ELEVATOR DISCONNECT TO BE REPLACED. CONTRACTOR TO RETAIN ASSOCIATED FEED AND CONDUIT TO SUIT NEW UNIT.

APPROXIMATE LOCATION OF EXISTING ELEVATOR CAB LIGHT DISCONNECT TO BE REPLACED. CONTRACTOR TO RETAIN AND EXTEND ASSOCIATED FEED AND CONDUIT TO SUIT NEW UNIT. REFER TO NEW WORK FOR ADDITIONAL INFORMATION.

(4) APPROXIMATE LOCATION OF EXISTING ELEVATOR MOTOR TO BE

STAIR 4

ELEV. 3&4 FRW

TYPICAL OF 6

ELEVATOR # 3 & 4 BASEMENT LEVEL B3 ELECTRICAL DEMOLITION / 3

LANDINGS

 $\langle 5 \rangle$ APPROXIMATE LOCATION OF EXISTING ELECTRICAL PANEL RATED 200A, 480/277V-3PH, 4 WIRE SERVING ELEVATORS. REFER TO NEW WORK FOR ADDITIONAL INFORMATION.

NEW WORK FOR ADDITIONAL INFORMATION.

- ERW EXISTING UNIT/DEVICE TO BE REPLACED AT SAME LOCATION. CONTRACTOR TO RETAIN ASSOCIATED WIRING AND CONDUIT TO SUIT NEW. REFER TO NEW WORK FOR ADDITIONAL INFORMATION.
- EXISTING TO BE REMOVED. CONTRACTOR TO REMOVE ASSOCIATED DEVICES, WIRING

DEMOLITION GENERAL NOTES

- REMOVE ALL INDICATED ELECTRICAL EQUIPMENT, ACCESSORIES, CONTROLS, DEVICES, AND ASSOCIATED CONDUIT AND WIRING BACK TO SOURCE OR LAST DEVICE.
- 3. THE ELECTRICAL CONTRACTOR SHALL VISIT THE SITE AND BECOME
- 4. ANY SYSTEMS OR EQUIPMENT TO REMAIN ACTIVE DURING RENOVATION
- 6. ANY ELECTRICAL EQUIPMENT TO BE REMOVED AND REUSED OR TURNED OVER TO THE OWNER, AT OWNERS REQUEST, OR AS INDICATED ON THE DRAWINGS SHALL BE CAREFULLY REMOVED AND STORED TO PREVENT
- 7. THE ELECTRICAL CONTRACTOR SHALL ALSO REVIEW THE ARCHITECTURAL
- THE OWNER IN ADVANCE PRIOR TO COMMENCEMENT OF ANY WORK.
- WITH THAT OF OTHER TRADES IN ORDER TO AVOID CONFLICTS.
- 10. ELECTRICAL COMPONENTS SHOWN ON THE DEMOLITION DRAWINGS, AND THE
- REGULATIONS.
- 14. WHERE ELECTRICAL EQUIPMENT & DEVICES ARE BEING REMOVED,

<u>ELEVATORS 3 & 4</u> TYPICAL AREA OF WORK FOR GROUND THRU 6TH FLOOR

THORIT DERNIZ IE .UTHORT

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NO. DATE BY

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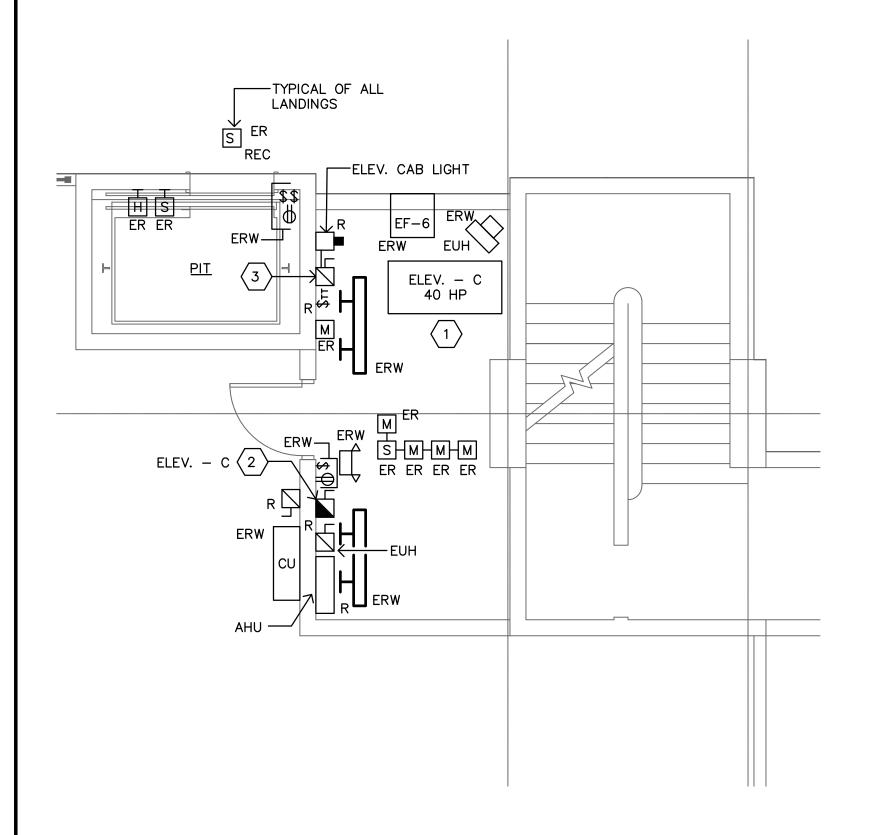
REVISIONS DRAWING TITLE TEMPLE STREET-ELECTRICAL

DEMOLITION PART PLANS DRAWING NO.

> SCALE: AS NOTED DATE: JULY 2025 PROJECT NO. 20-20176.00-2 NHPA NO. 21-011

TS-E-1


DESIGN DRAWN CH'KD.
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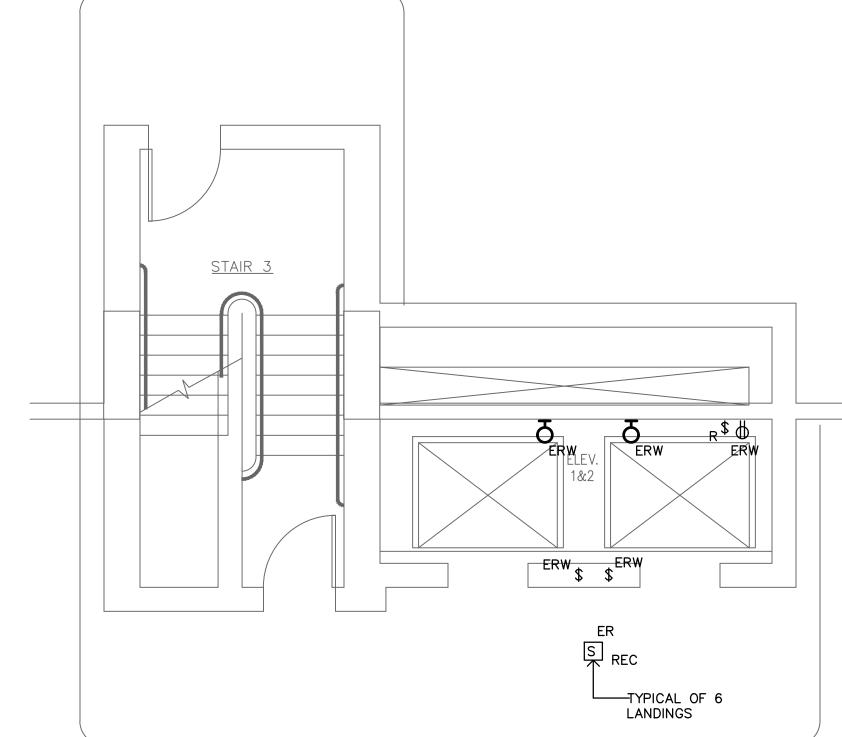



ELEVATOR - "C" GROUND LEVEL

SCALE: 1/4" = 1'-0"

MACHINE ROOM ELECTRICAL DEMOLITION




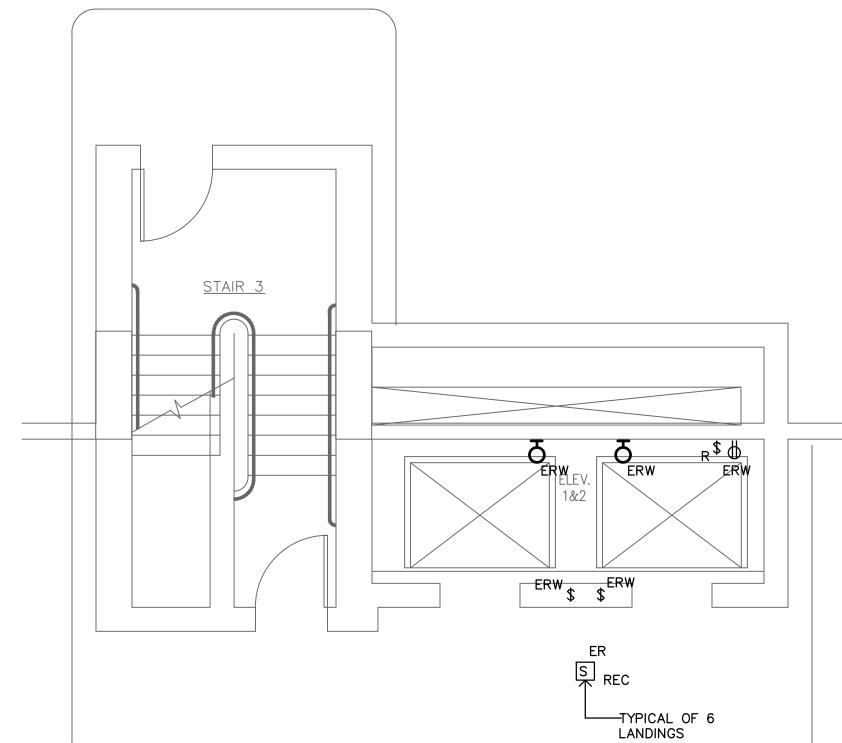

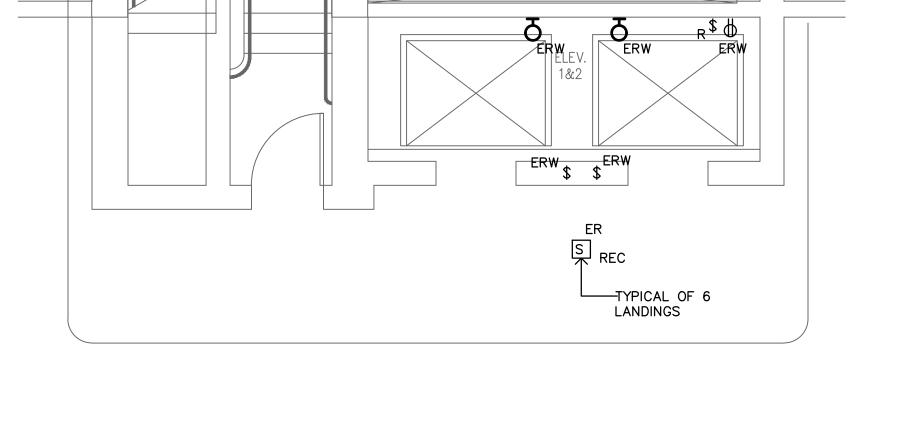


ELEVATOR # 1 & 2 BASEMENT LEVEL B3 ELECTRICAL DEMOLITION


SCALE: 1/4" = 1'-0"

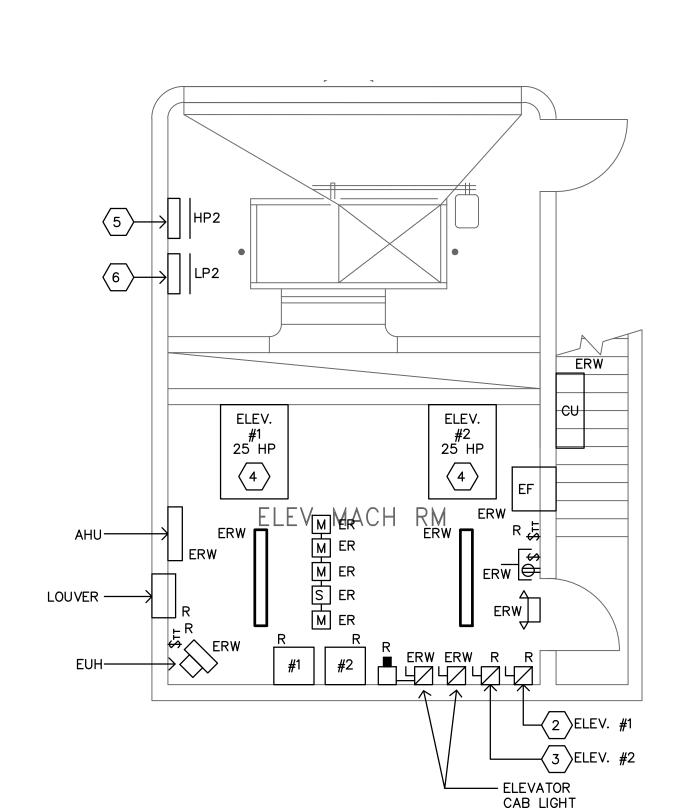

PENTHOUSE ELEVATOR MACHINE ROOM # 2 ELECTRICAL DEMOLITION


SCALE: 1/4" = 1'-0"

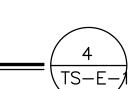

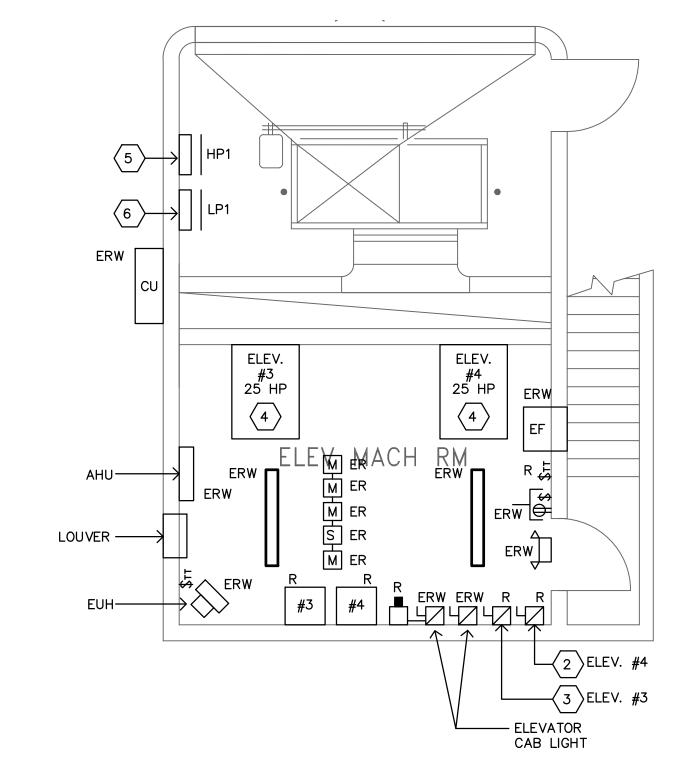

PENTHOUSE ELEVATOR MACHINE ROOM # 3 ELECTRICAL DEMOLITION

SCALE: 1/4" = 1'-0"

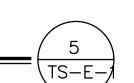

SCALE: 1/4" = 1'-0"

ELEVATOR - "C" TYPICAL GROUND THRU 9TH LEVEL AND MACHINE ROOM ELECTRICAL POWER NEW WORK

NEW WORK KEY NOTES

DISCONNECT SHALL BE LOCKABLE IN THE OPEN POSITION. PROVIDE AUXILIARY CONTACT WITHIN DISCONNECT TO BE INTERCONNECTED WITH

NOT COMPATIBLE WITH NEW CONNECTION. PROVIDE ALL COMPONENTS NECESSARY FOR A COMPLETE MANUFACTURER/ENGINEER APPROVED

INTERCONNECTED WITH ELEVATOR CONTROLLERS. INTERCONNECT DISCONNECT WITH ELEVATOR MOTOR AND ELECTRICAL PANEL "HP-1 OR HP-2"

PROPOSED LOCATION FOR FUSED DISCONNECT SWITCH RATED FOR 30A, 120V-1 PHASE TO SUIT CAB LIGHTING AND VENTILATION. DISCONNECT

PROVIDE NEW BRANCH CIRCUIT IF EXISTING IS NOT DEDICATED TO POWER RECEPTACLES. PROVIDE 20A-1P, 3/4"C, 2#12, 1#12G FROM LB2 (FOR

PROVIDE NEW BRANCH CIRCUIT IF EXISTING IS NOT DEDICATED TO LIGHTING. PROVIDE 20A-1P, 3/4"C, 2#12, 1#12G FROM LB2 (FOR ELEVATOR

APPROXIMATE LOCATION OF EXISTING ELECTRICAL PANEL RATED FOR 200A, 480/277V-3PH, 4 WIRE SERVING ELEVATORS. CONTRACTOR TO REWORK PANEL AS REQUIRED TO ACCOMMODATE NEW CIRCUIT BREAKERS AND UPDATE PANEL DIRECTORY WITH NEW BREAKER DESIGNATION.

APPROXIMATE LOCATION OF EXISTING ELECTRICAL PANEL RATED 200A, 120/208V-3PH, 4 WIRE SERVING ELEVATOR CAB LIGHTING, M.R. LIGHTING, POWER RECEPTACLE AND ELEVATOR CONTROLLERS. CONTRACTOR TO REWORK PANEL AS REQUIRED TO ACCOMMODATE NEW CIRCUIT

NEW WORK ABBREVIATION

DRAWING GENERAL NOTES

ELECTRICAL CONTRACTOR ASSUMES ALL RESPONSIBILITY DURING CONSTRUCTION TO PROTECT MATERIALS AND EQUIPMENT. ANY & ALL DAMAGED ITEMS & EQUIPMENT

LINE VOLTAGE WIRING RATED FOR 120V SERVING ELEVATOR DEVICES CAN BE INSTALLED WITHIN ELEVATOR HOISTWAY. PROVIDE SHUNT-TRIP BREAKER FOR ALL CIRCUIT BREAKER SERVING ELEVATOR WITH SPRINKLER HEAD IN THE ELEVATOR HOISTWAY.

SHALL BE LOCKABLE IN THE OPEN POSITION. INTERCONNECT WITH CAB LIGHTING, VENTILATION AND EXISTING/EXTENDED BRANCH CIRCUIT. PROVIDE 20A-1P, 3/4"C, 3#12 IF EXISTING CIRCUIT AND BREAKER IS NOT COMPATIBLE WITH NEW CONNECTION. PROVIDE ALL COMPONENTS

NEW ELEVATOR CONTROLLER TO BE PROVIDED AND INSTALLED BY ELEVATOR INSTALLER. CONTRACTOR TO INTERCONNECT UNIT WITH

NECESSARY FOR A COMPLETE MANUFACTURER/ENGINEER APPROVED INSTALLATION TO BE FULLY OPERATIONAL

ELEVATOR -C) LOCATED IN BASEMENT OR LP1, LP2 (FOR ELEVATOR 1,2,3,4) LOCATED IN FAN ROOM.

PROPOSED LOCATION FOR FUSED DISCONNECT SWITCH RATED FOR 60AMP-3P WITH 40AMP FUSE, 480V-3PHASE TO SUIT CORRESPONDING ELEVATOR. DISCONNECT SHALL BE LOCKABLE IN THE OPEN POSITION. PROVIDE AUXILIARY CONTACT WITHIN DISCONNECT TO BE

LOCATED IN FAN ROOM. PROVIDE 60A-3P CIRCUIT BREAKER IN PANEL, 1"C, 4#6 AND ALL COMPONENTS NECESSARY FOR A COMPLETE

SCALE: 1/4" = 1'-0"

DISCONNECT.

INSTALLATION TO BE FULLY OPERATIONAL

MANUFACTURER/ENGINEER APPROVED INSTALLATION TO BE FULLY OPERATIONAL.

CONNECT TO ROOM LIGHTING CIRCUIT AHEAD OF SWITCHING DEVICE.

BREAKERS AND UPDATE PANEL DIRECTORY WITH NEW BREAKER DESIGNATION.


ER EXISTING TO REMAIN (UNLESS OTHERWISE INDICATED, SHOWN FOR REFERENCE PURPOSE ONLY).

DURING CONSTRUCTION SHALL BE REPLACED AT NO ADDITIONAL COST TO THE OWNER.

REW REPLACED EXISTING UNIT/DEVICE AT SAME LOCATION. RECONNECT TO EXISTING WIRING AND CONDUIT.


CORRESPONDING ELEVATOR DISCONNECT AND PROVIDE ASSOCIATED WIRING AND CONDUIT.

-C) LOCATED IN BASEMENT OR LP1, LP2 (FOR ELEVATOR 1,2,3,4) LOCATED IN FAN ROOM.

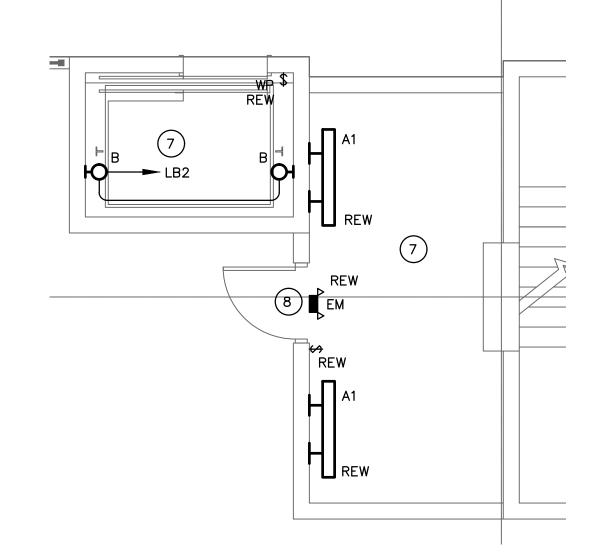


ELEVATOR - "C" TYPICAL GROUND THRU 9TH LEVEL AND MACHINE ROOM

ELECTRICAL LIGHTING NEW WORK SCALE: 1/4" = 1'-0"

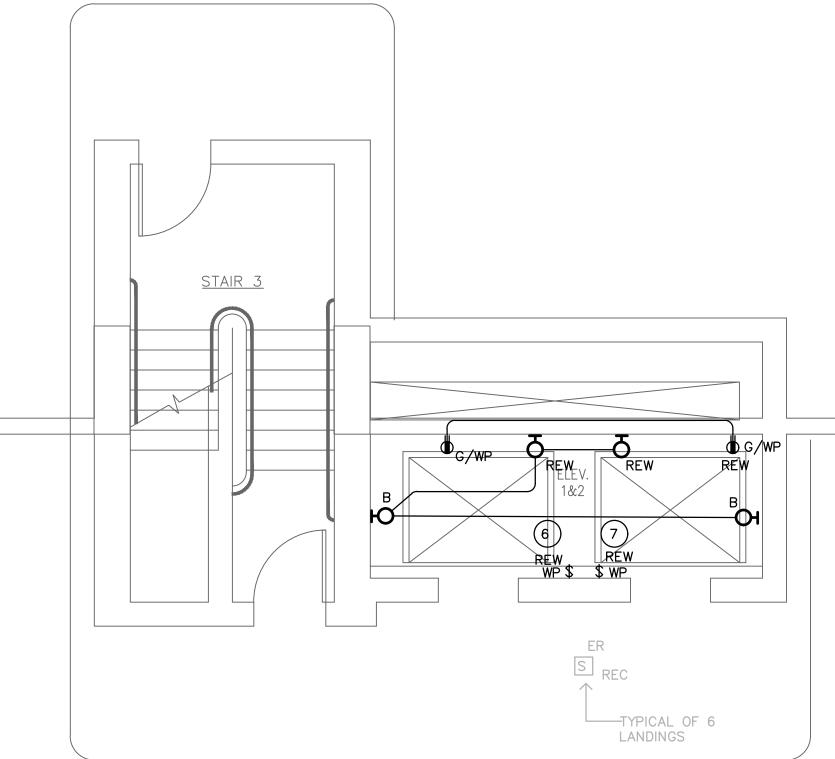



ELEVATOR # 1 & 2 BASEMENT LEVEL B3 ELECTRICAL NEW WORK SCALE: 1/4" = 1'-0"

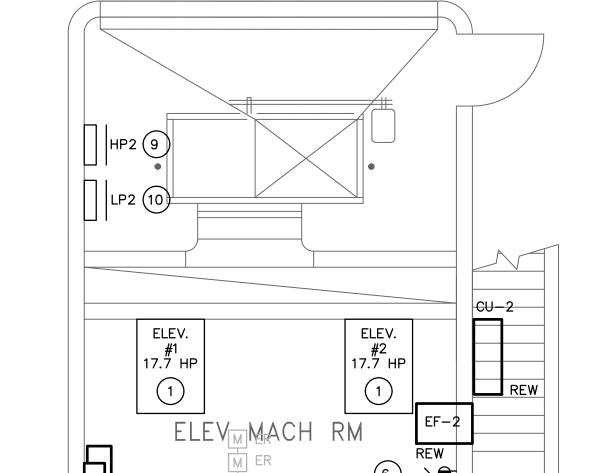


17,19,21 HP2

PENTHOUSE ELEVATOR MACHINE ROOM # 2

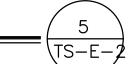

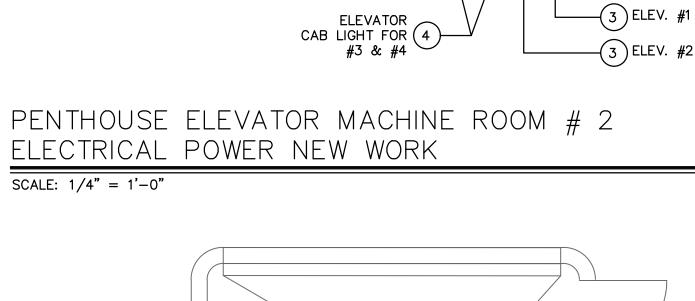

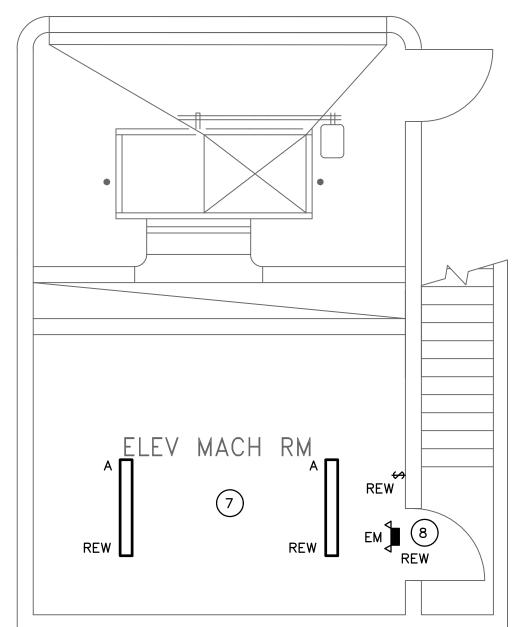

PENTHOUSE ELEVATOR MACHINE ROOM # 2 ELECTRICAL LIGHTING NEW WORK

SCALE: 1/4" = 1'-0"




ELEVATOR # 3 & 4 BASEMENT LEVEL B3 ELECTRICAL NEW WORK/ SCALE: 1/4" = 1'-0"

TYPICAL OF 6

LANDINGS


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PENTHOUSE ELEVATOR MACHINE ROOM # 3 ELECTRICAL POWER NEW WORK

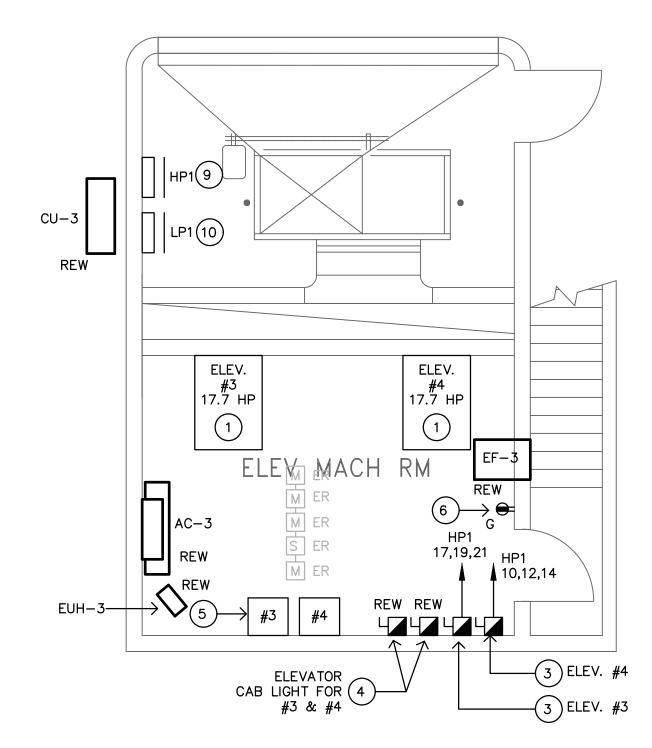SCALE: 1/4" = 1'-0"

SCALE: 1/4" = 1'-0"



PENTHOUSE ELEVATOR MACHINE ROOM # 3 ELECTRICAL LIGHTING NEW WORK

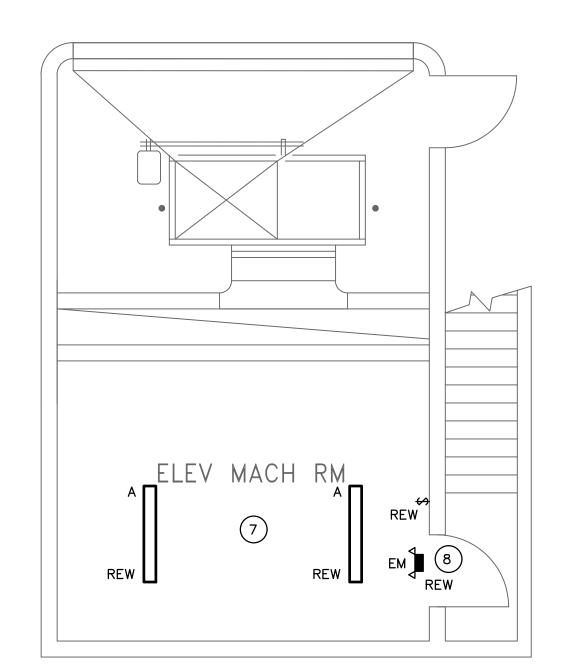TS-E-2

NO. DATE BY **REVISIONS** DRAWING TITLE


TEMPLE STREET -ELECTRICAL NEW WORK PART PLANS


DRAWING NO. TS-E-2

SCALE: AS NOTED DATE: JULY 2025

PROJECT NO. 20-20176.00-2 NHPA NO. 21-011 DESIGN DRAWN CH'KD.
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ALL WORK SHALL BE DONE IN ACCORDANCE WITH THE STANDARD GENERAL CONDITIONS OF THE CONSTRUCTION CONTRACT, AIA DOCUMENT 201, LATEST EDITION. ELECTRICAL CONTRACTOR SHALL INSTALL ALL EQUIPMENT IN ACCORDANCE WITH MANUFACTURERS INSTRUCTIONS AND/OR

ELECTRICAL CONTRACTOR SHALL GIVE OWNER SEVEN (7) DAYS ADVANCE NOTICE OF SHUTDOWNS. SHUTDOWNS TO BE KEPT TO A MINIMUM. AT NO TIME SHALL THE BUILDING/SPACE BE LEFT WITHOUT COMMERCIAL POWER IN FULL OPERATING ORDER.

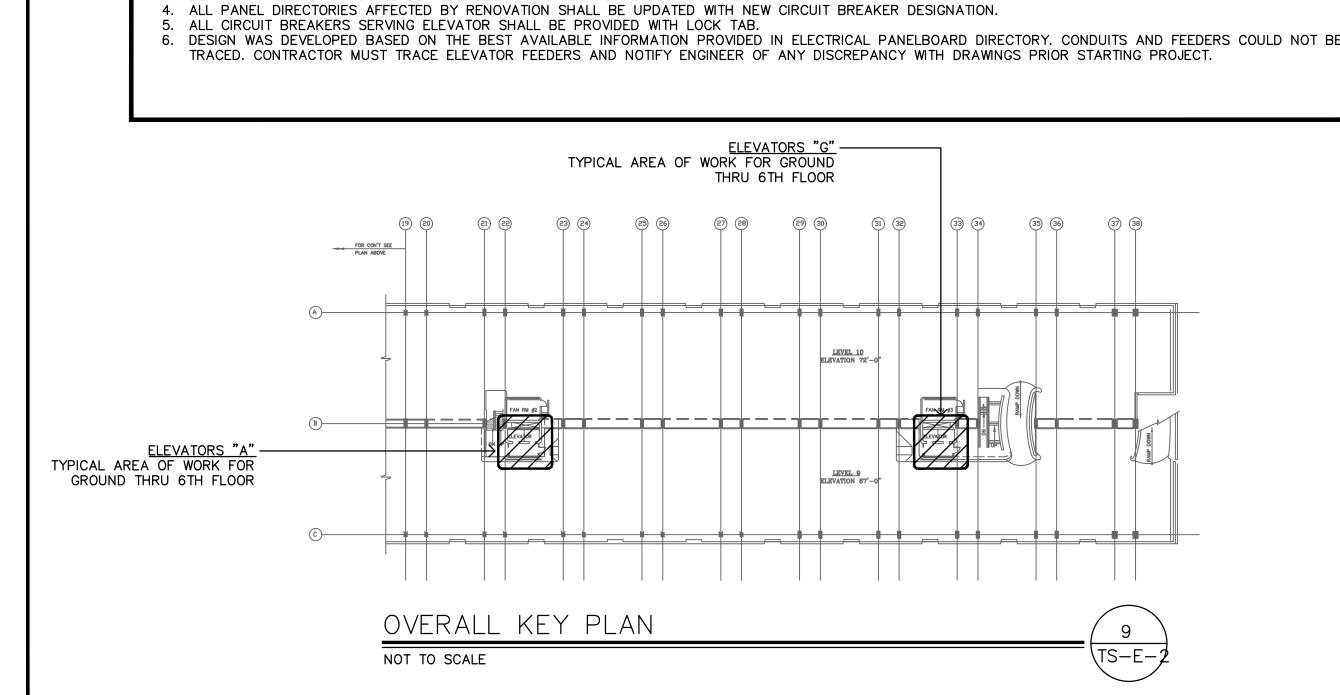OWNER THAT THE EQUIPMENT IS IN FULL OPERATING ORDER. 9. ELECTRICAL CONTRACTOR SHALL RESTORE ALL AREAS DISTURBED TO THEIR ORIGINAL CONDITION. ELECTRICAL CONTRACTOR IS

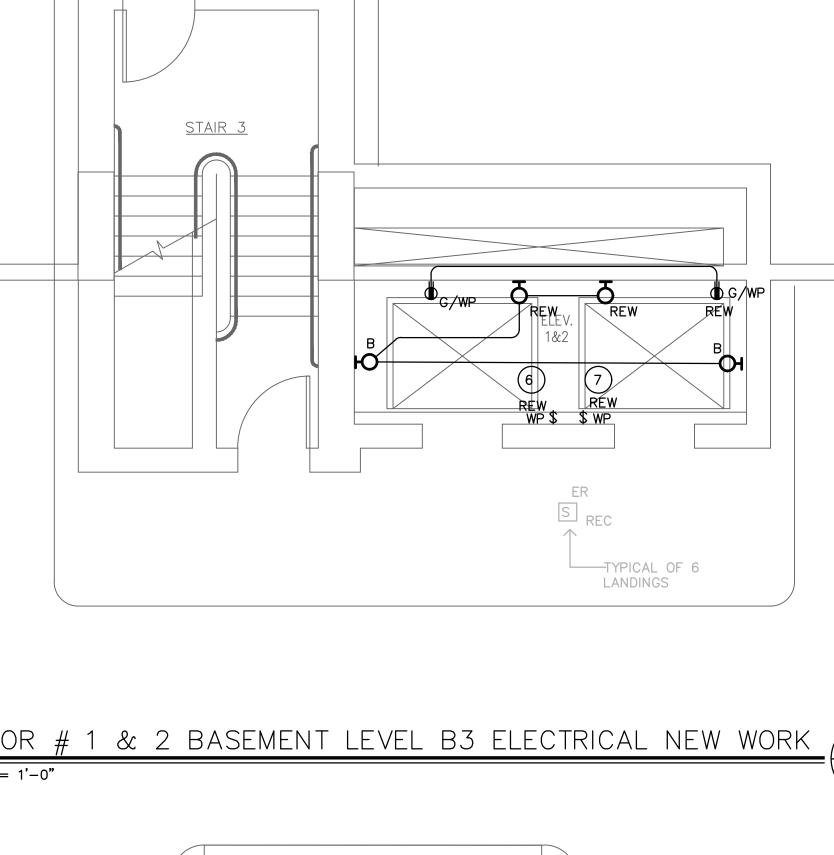8. ELECTRICAL CONTRACTOR SHALL BE RESPONSIBLE FOR TESTING OF ALL PHASES OF THE WORK AND TO DEMONSTRATE TO

RESPONSIBLE FOR ALL CUTTING, PATCHING, PAINTING, CLEAN-UP, ELECTRICAL DEBRIS REMOVAL AND GENERAL COORDINATION OF THE WORK EFFORT AS REQUIRED FOR THE INSTALLATION OF THE ELECTRICAL ITEMS OF WORK.

10. THE TERM "PROVIDE" SHALL MEAN TO FURNISH AND INSTALL IN COMPLETE WORKING ORDER.

11. THE SCOPE OF WORK IS AS SHOWN ON THE PLANS AND DETAILED IN THE SPECIFICATIONS.

12. ALL THE WIRE SIZES ARE BASED ON COPPER; ALUMINUM IS NOT TO BE USED.

REQUIREMENTS FOR PROPER OPERATION AND MAINTENANCE.

LOCAL CODES.

13. ALL WIRING METHODS ARE TO BE IN ACCORDANCE WITH THE CURRENT ISSUE OF THE NATIONAL ELECTRICAL CODE, AND APPLICABLE LOCAL CODES. ALL WIRING IS TO BE IN CONDUIT, UNLESS SPECIFICALLY NOTED OTHERWISE. ALL WIRING IS TO BE CONCEALED.

14. PROVIDE INDEPENDENT SEISMIC SUPPORT OF ALL ELECTRICAL EQUIPMENT PER INTERNATIONAL BUILDING CODE.

15. ELECTRICAL CONTRACTOR SHALL SECURE ALL PERMITS AND PAY FOR ALL REQUIRED FEES.

16. ELECTRICAL CONTRACTOR SHALL WARRANT AND GUARANTEE ALL MATERIALS AND WORKMANSHIP FOR A PERIOD OF ONE (1) YEAR FROM THE DATE OF FINAL ACCEPTANCE BY THE OWNER.

17. ELECTRICAL CONTRACTOR SHALL PROVIDE PROOF OF LIABILITY AND PROPERTY INSURANCE TO THE OWNER. ALL DEDUCTIBLES SHALL BE PAID FOR BY THE ELECTRICAL CONTRACTOR IN THE EVENT OF A CLAIM.

18. PERSONNEL SAFETY IS OF PRIME IMPORTANCE. NO HAZARDOUS CONDITION MUST BE ALLOWED. EVERY CARE MUST BE TAKEN

TO PROTECT CONSTRUCTION AND OTHER PERSONNEL. CLEANUP IS TO BE DONE ON A DAILY BASIS. ELECTRICAL CONTRACTOR TO REMOVE AND DISPOSE OF REFUSE FROM SITE. 19. ELECTRICAL CONTRACTOR SHALL PROVIDE SHOP DRAWINGS FOR APPROVAL FOR ALL LIGHTING FIXTURES, PANELS, SWITCHES,

RECEPTACLES, ETC.

20. ELECTRICAL CONTRACTOR TO VERIFY LIGHTING FIXTURE MOUNTING REQUIREMENTS FOR VARIOUS CEILING TYPES AND ORDER APPROPRIATE HARDWARE.

21. COORDINATE EXACT PLACEMENT OF EQUIPMENT WITH ELEVATOR AND MECHANICAL PLANS. MAKE FIELD ADJUSTMENTS AS

REQUIRED TO AVOID CONFLICTS, VERIFY WITH OWNER. 22. ELECTRICAL CONTRACTOR TO COORDINATE WITH ELEVATOR INSTALLER AND MECHANICAL CONTRACTOR FOR ITEMS SUPPLIED BY

THE MECHANICAL/OTHER DIVISIONS BUT INSTALLED BY THE ELECTRICAL CONTRACTOR. ELECTRICAL CONTRACTOR TO REVIEW ALL THE PLANS FOR THE PROJECT FOR ELECTRICAL WORK.

23. ELECTRICAL CONTRACTOR TO VERIFY ALL EQUIPMENT POWER NEEDS WITH THE ACTUAL SHOP DRAWINGS FOR THE EQUIPMENT TO BE USED, PRIOR TO STARTING ANY ELECTRICAL WORK.

24. SPECIFICATION SECTIONS, GENERAL CONDITIONS, SUPPLEMENTAL GENERAL CONDITIONS AND DRAWINGS ARE INTEGRAL PARTS OF CONTRACT DOCUMENTS.

25. THE DISPOSAL OF ALL UNUSED EXISTING ELECTRICAL EQUIPMENT REMOVED IS A PART OF THE SCOPE OF WORK. THE ELECTRICAL CONTRACTOR SHALL DISPOSE OF ALL SUCH EQUIPMENT, INCLUDING HAZARDOUS PCB CONTAINING BALLASTS, IN A MANNER CONSISTENT WITH STATE OF CT. DEPARTMENT OF ENVIRONMENTAL PROTECTION REGULATIONS, CURRENT ISSUE.

26. SHARED NEUTRALS ARE NOT TO BE USED. PROVIDE SEPARATE NEUTRALS FOR ALL CIRCUITS.

27. PRIOR TO SUBMISSION OF BIDS GIVE WRITTEN NOTICE TO ARCHITECT AND ENGINEER OF ANY MATERIAL OR APPARATUS THAT IS INADEQUATE, UNSUITABLE FOR THE USE, IN VIOLATION OF LAWS, ORDINANCES, RULES, CODES OR ANY REGULATIONS OF AUTHORITIES HAVING JURISDICTION OR ANY NECESSARY ITEMS OF WORK THAT HAS BEEN OMITTED. CONTRACTOR AFFIRMS THAT IN ABSENT OF SUCH NOTICE, ALL SYSTEMS WILL FUNCTION SATISFACTORILY WITHOUT ADDITIONAL EXTRA COMPENSATION.

28. ALL PART NUMBERS ARE PROVIDED FOR THE CONVENIENCE OF THE CONTRACTOR. THEY ARE NOT TO BE CONSIDERED THE COMPLETE SPECIFICATION OF THE PRODUCT. THE PART NUMBER AND DESCRIPTION WILL BE THE COMPLETE SPECIFICATION. IN THE EVENT OF A DISCREPANCY BETWEEN THE TWO (2), THE MORE STRINGENT, MORE COSTLY FEATURE/PERFORMANCE WILL BE

29. FOR ALL GRADE LEVEL HVAC EQUIPMENT, THE ELECTRICAL CONTRACTOR SHALL SUPPLY A GFCI WP, 20A RECEPTACLE FOR EQUIPMENT SERVICING. ALL DISCONNECT SWITCHES ARE TO BE HEAVY DUTY, FUSED, WEATHER PROOF (WP) DEVICES.

30. NO LOW VOLTAGE WIRING SHALL BE PERMITTED IN THE SAME RACEWAY AS POWER WIRING.

31. FURNISH & INSTALL GFCI RECEPTACLES IN ALL WET LOCATIONS.

32. PROVIDE PULL STRINGS IN ALL EMPTY RACEWAYS.

33. CIRCUIT NUMBERS ARE INDICATED FOR INTENT ONLY. THE ELECTRICAL CONTRACTOR SHALL ADJUST ACCORDINGLY IN THE FIELD, TO BALANCE CIRCUITS EVENLY ON ALL PHASES.

34. MINIMUM CONDUCTOR SIZE, UNLESS OTHERWISE NOTED SHALL BE #12 FOR ALL BRANCH CIRCUIT RUNS UP TO THE FIRST OUTLET; OVER 100 FEET, #10; OVER 150 FEET, #8; INCREASE CONDUIT SIZE TO SUIT.

35. ELECTRICAL CONTRACTOR TO VERIFY LOADS, SETTINGS, OVERCURRENT PROTECTION, ETC. TO INSURE COMPATIBILITY OF EQUIPMENT.

36. NO PENETRATIONS ARE ALLOWED INTO STAIR ENCLOSURES EXCEPT AS REQUIRED FOR SERVICES UTILIZED IN THE STAIR.

37. REPAIR AND REPLACE AT NO COST TO OWNER ALL EQUIPMENT AND MATERIALS DAMAGED DURING CONSTRUCTION.

38. ELECTRICAL CONTRACTOR SHALL COORDINATE ALL DEMOLITION WITH BASE BUILDING ELECTRICIAN.

39. PRODUCTS SHALL NOT BE INSTALLED IN PROMINENT LOCATIONS UNLESS NO ALTERNATIVE EXISTS. ITEMS SHALL BE CENTERED ON WALL OR CEILING TREATMENT AND ON ONE ANOTHER AS APPLICABLE. THIS INCLUDES BUT IS NOT LIMITED TO ACCESS PANELS, LIGHTING FIXTURES, SWITCHES, THERMOSTATS, FIRE ALARM DEVICES, EXIT SIGNS, ELECTRICAL PANELS, AND ANNUNCIATOR PANELS OF ANY KIND.

40. ELECTRICAL CONDUITS & BOXES SHALL BE CONCEALED IN WALLS OR ABOVE CEILINGS WHEREVER POSSIBLE.

41. INSTALLATIONS ON EXISTING WALLS SHALL BE RUN WITH SURFACE RACEWAY PAINTED TO MATCH WALL FINISH AND SURFACE BOXES. USE METAL WIREMOLD FOR INSTALLATIONS WITHIN OCCUPIED AREAS.

42. POWER RECEPTACLES COVER PLATES SHALL BE LABELED WITH DESIGNATED PANEL AND CIRCUIT NUMBER SERVING UNIT.

NOTES EXISTING PANELBOARD SURFACE MOUNTED RATED FOR 120/208V-3PH. WATTS 45 | | ENCLOSED CIRCUIT BREAKER. FUSED DISCONNECT SWITCH. 45 NON-FUSED DISCONNECT SWITCH. 45 **⇒** DUPLEX RECEPTACLE. DUPLEX GROUND FAULT RECEPTACLE MOUNT 48" A.F.F. 4.4 WALL MOUNTED LIGHT FIXTURE. LINEAR WALL MOUNTED LIGHT FIXTURE SINGLE-POLE SWITCH; MOUNT AT 48" AFF. FIRE ALARM ADDRESSABLE RELAY FIRE ALARM SHUNT TRIP HEAT DETECTOR.

REC

REC

—— CONDUIT AND WIRE

WP WEATHERPROOF

— — CONDUIT AND WIRE, SWITCHED

GROUND FAULT INTERRUPTER

BRANCH CIRCUIT HOMERUN.

FIRE ALARM RECALL SMOKE DETECTOR.

WALL MOUNTED FIRE ALARM HEAT DETECTOR

ELECTRICAL

VOLTAGE

UNIVERSAL

UNIVERSAL

UNIVERSAL

UNIVERSAL

DRIVER

ELECTRONIC

ELECTRONIC

ELECTRONIC

ELECTRONIC

NOTES

LIGHTING FIXTURE SCHEDULE

MANUFACTURER/

MODEL NUMBER

DAY-BRITE

DAY-BRITE

DAY-BRITE

DAY-BRITE

CLU2NW

FSI455L840-UNV

FSI455L840-UNV

DWAE45L840-2-UNV-MD360W

LAMP

COLOR

LED 4000K

LED | 4000K

LED | 4000K

LED N/A

TEMP

(1) FURNISH WITH ALL REQUIRED MOUNTING HARDWARE AND CONNECTING CABLE.

DESCRIPTION

4' LENGTH SURFACE MOUNT VAPORTIGHT LED WITH

4' LENGTH SURFACE MOUNT LINEAR LED WITH

SAME AS TYPE - A TO BE WALL MOUNTED

DAMAGE RESISTANCE ACRYLIC LENS


TWIN HEAD EMERGENCY WALL PACK


FROSTED ACRYLIC LENS

DESIGNATION

(2) ALL FIXTURES SHALL BE CAPABLE OF OPERATING IN COLD TEMP (0° F).

STEEL ROD ---

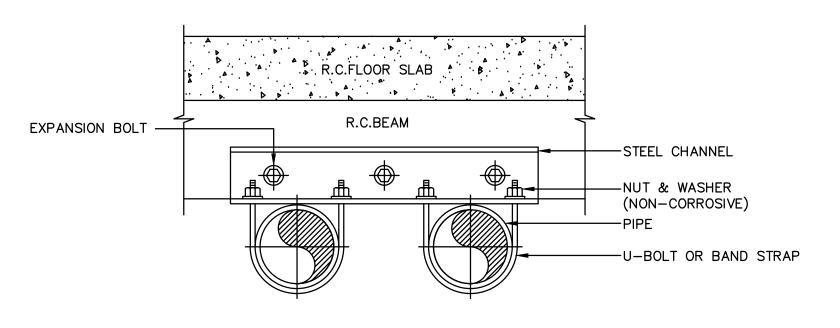

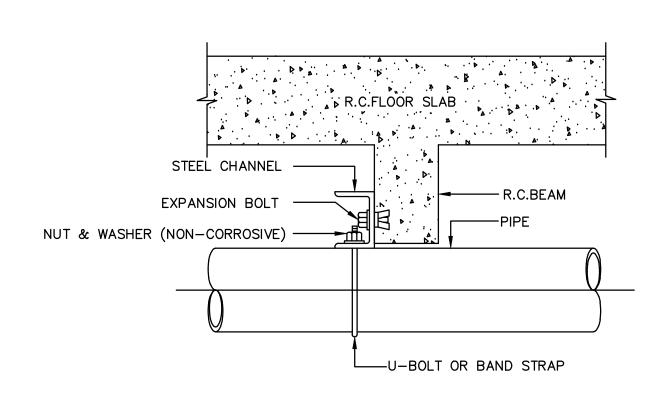

ELEVATION


PIPE HANGER FROM BEAM




GENERAL NOTES:


1. PROVIDE UL LISTED FIRE/SMOKE PENETRATION ASSEMBLY IN ACCORDANCE W/UL1479, ASTM E 814 REQUIREMENTS FOR WALL TYPE, RATING, PIPE SIZE

WALL/FLOOR BEING PENETRATED - SEE PROJECT MANUAL. REFER TO DRAWINGS FOR WALL/FLOOR RATINGS AND LOCATIONS.

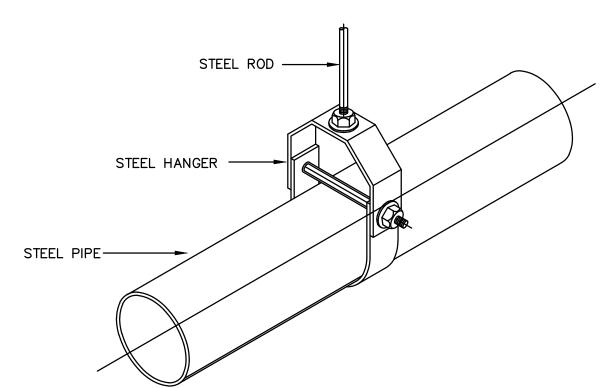

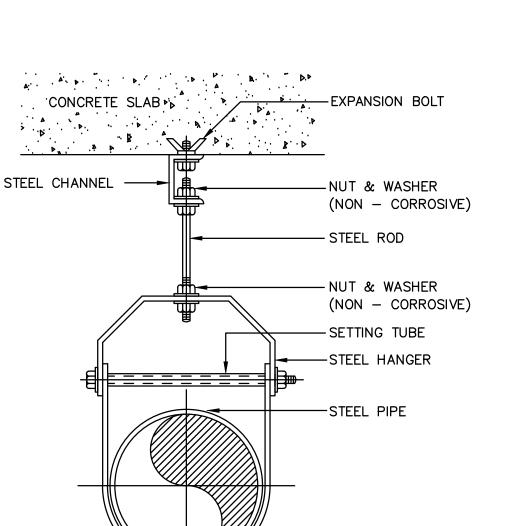



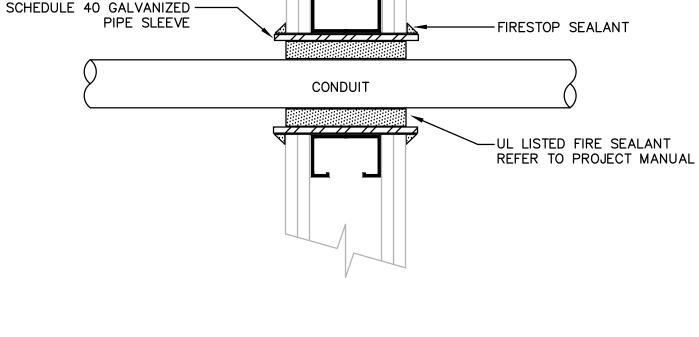


-FIRE OR SMOKE RATED

DRYWALL PARTITION

ABBREVIATION

ELECTRICAL LEGEND

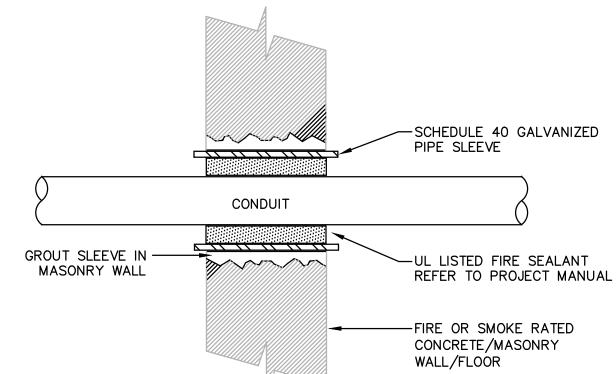



2. FIRESTOPPING SHALL HAVE A RATING EQUAL TO OR GREATER THAN THE

 \bigcirc \Box

NO. DATE BY

DRAWING TITLE TEMPLE STREET . ELECTRICAL LEGEND. **NOTES**

DRAWING NO.

SCALE: AS NOTED DATE: JULY 2025

TS-E-3


PROJECT NO. 20-20176.00-2 NHPA NO. 21-011 DESIGN DRAWN CH'KD J.R.P. J.R.P. R.R.B.


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TEMPLE STREET GARAGE

SCALE: 1/4" = 1'-0"


GROUND FLOOR EMR DEMOLITION PLAN



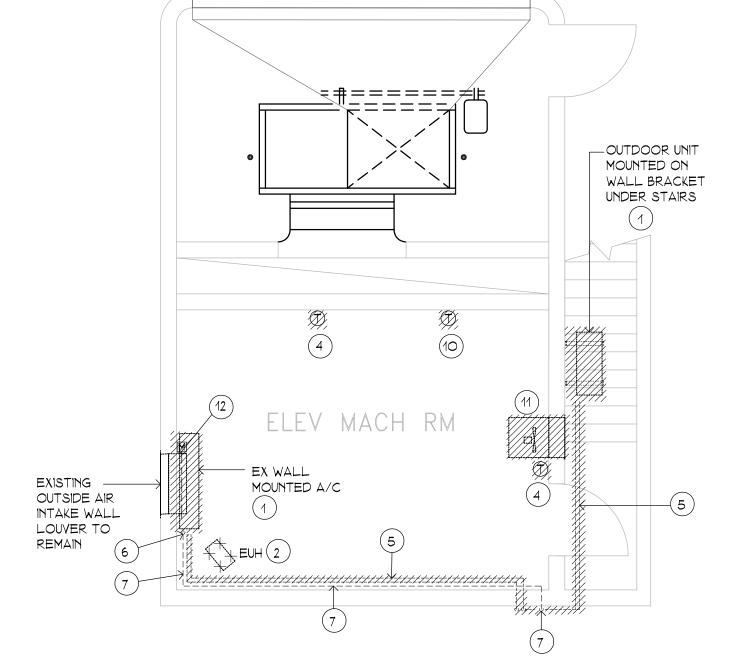


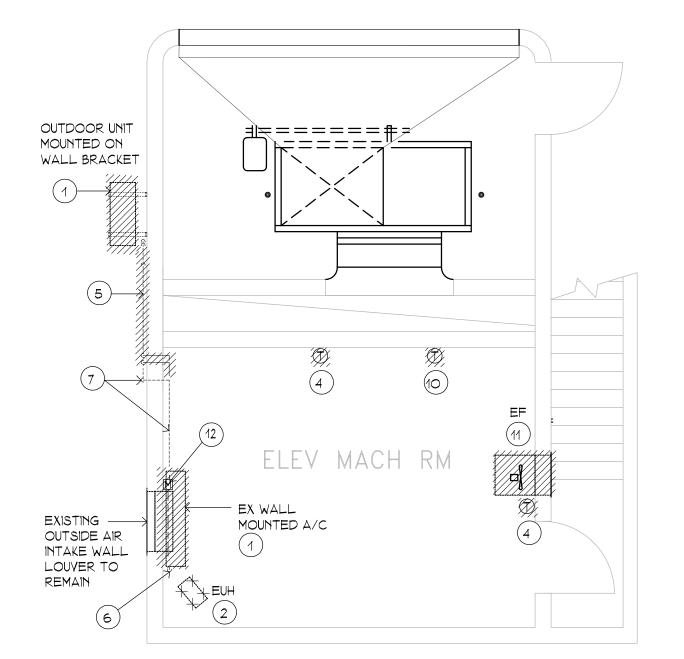




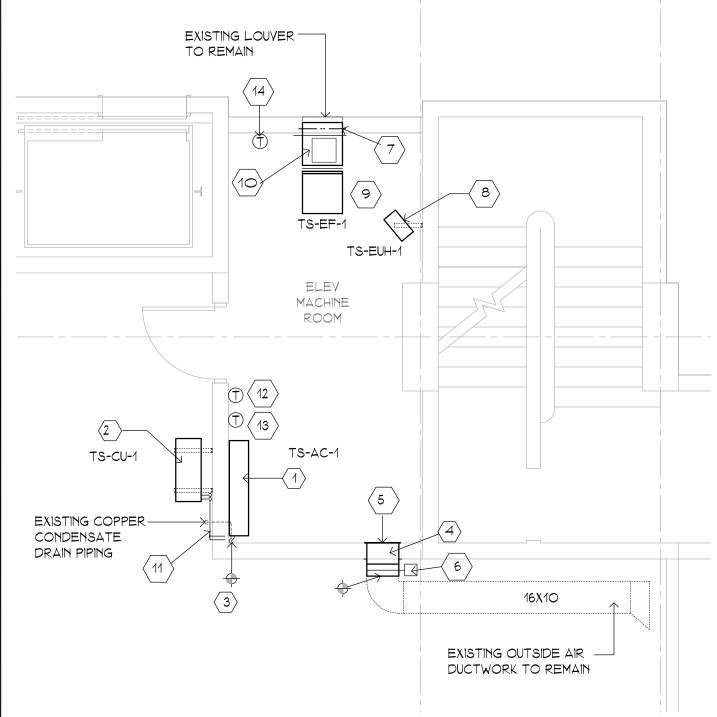



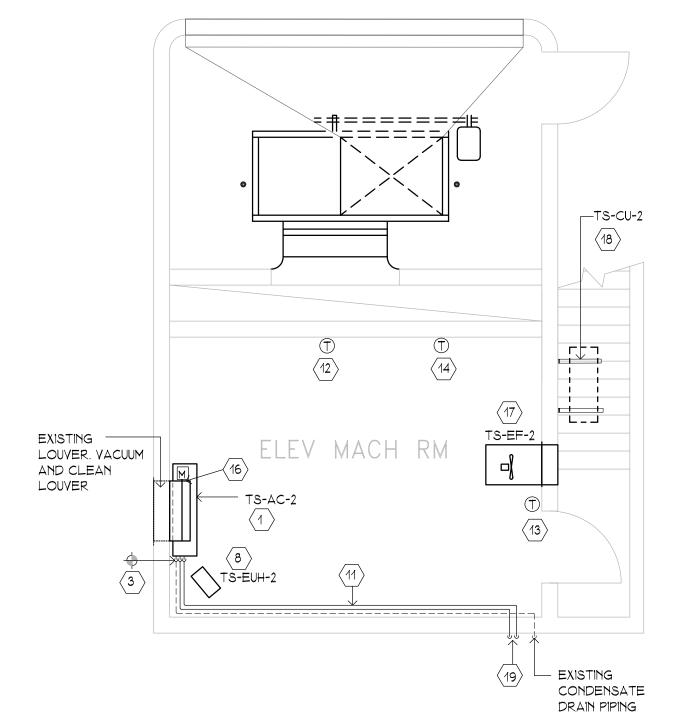

ROOF EMR FAN ROOM #2 MECHANICAL PLAN TS-M-1 SCALE: 1/4" = 1'-0"

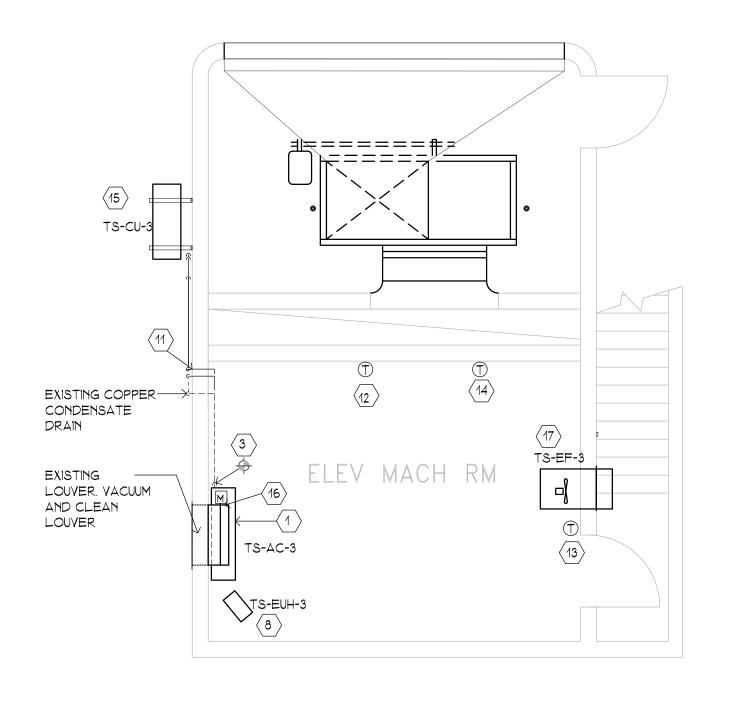

TEMPLE STREET GARAGE ROOF EMR FAN ROOM #3 MECHANICAL PLAN SCALE: 1/4" = 1'-0"

	INDO	OR UNIT				OUT	DOOR UNIT			COOLING PERFORM	TU/HR) ELECTRICAL REFRIGERATION PIPING (IN) V/PH/HZ MCA RFS LIQUID / VAPOR REFRIGERATION PIPING (IN) LIQUID / VAPOR							
TAG	AREA SERVED	TYPE AND	WXHXD	WEIGHT	TAG	MODEL	WXHXD	WEIGHT	CAPACITY	(BTU/HR)					RFS	, , ,	FRIGE	NOTES
		MODEL	INCH	(LBS)			INCH	(LBS)	MINIMUM	RATED	EER	SEER		AMP	AMP		М. П	
TS-AC-1	GROUND FLOOR EMR	WALL MOUNTED PKA-AK24NL	46.1 X 14.375 X 11.625	46	TS- CU-1	PUY-AH24NL	37.4 X 37.1 X 16.6	151	10,000	24,000	13.2	22.6	208-230/1/60	22	25	3/8 / 5/8	R454B	1 TO
TS-AC-2	ROOF EMR (FAN ROOM #2)	WALL MOUNTED PKA-AK24NL	46.1 X 14.375 X 11.625	46	TS-CU-2	PUY-AH24NL	37.4 X 37.1 X 16.6	151	10,000	24,000	13.2	22.6	208-230/1/60	22	25	3/8 / 5/8	R454B	1 TO :
TS-AC-3	ROOF EMR (FAN ROOM #3)	WALL MOUNTED PKA-AK24NL	46.1 X 14.375 X 11.625	46	TS-CU-3	PUY-AH24NL	37.4 X 37.1 X 16.6	151	10,000	24,000	13.2	22.6	208-230/1/60	22	25	3/8 / 5/8	R454B	1 TO :
NOTES				1			3 880//		ANDIENT	(NC 8 A E E)		2.600	ING OPERATION	1001/	N TO	10 DEC E		

ELEC	TRIC UNIT HE	ATER	R SCHEI	DULE			/n	N OWARI	
TAG	LOCATION	DCATION CFM HEATING ELECTRICAL DATA CONTI					(BASED O	NOTES	
TS-EUH-1	GROUND FLR EMR	350	(KW)	VOLT/PH A 480/3 3.6		VOLT 24	MUHO3-41	1 , 2, 3, 4	
	ROOF EMR							1, 2, 3, 4	
TS-EUH-2	(FAN ROOM #2)	350	3.0	277/1	11	277	MUHO3-71	2, 3, 4	
TS-EUH-3	ROOF EMR (FAN ROOM #3)	350	3.0	277/1	11	277	MUHO3-71	2, 3, 4	

1. PROVIDE WITH FACTORY INSTALLED 24V CONTROL TRANSFORMER

LENGTH OF ELEMENTS

2. PROVIDE WITH AUTOMATIC RESET LINEAR THERMAL CUT-OUT,

CAPILLARY TYPE TO PROVIDE PROTECTION OVER ENTIRE

3. PROVIDE WITH WALL MOUNTED THERMOSTAT 4. PROVIDE DISCONNECT SWITCH

EXHA	LUST FAN SCHE	DULE		(₿△	ASED ON LO	OREN COOK)						
	AREA		STATIC			ELECTRI	ELECTRICAL		MOTOR			
TAG	SERVED	TYPE	CFM	PRESS (IN. WG.)	RPM	VOLTS/	HP	ENCLOSURE	RPM	MODEL	DAMPER ACTUATOR VOLTAGE	NOTES
TS-EF-1	GROUND FLR EMR	IN-LINE	800	0.20	1623	115/1	1/4	OPEN-EC	1725	100SQND-VF	115 V BACKFRAFT DAMPER	1, 3
TS-EF-2	ROOF EMR (FAN ROOM #2)	PACKAGED WALL FAN	1271	0.125	1530	115/1	1/4	OPEN-EC	1725	12XPD-EC	115 V SHUTTER	2, 3
TS-EF-3	ROOF EMR (FAN ROOM #3)	PACKAGED WALL FAN	1271	0.125	1530	115/1	1/4	OPEN-EC	1725	12XPD-EC	115 V SHUTTER	2, 3
NOTEs:						•		•				

1. DIRECT DRIVE IN-LINE EXHAUST FAN, PROVIDE WITH: DISCONNECT SWITCH, FAN HOUSING WITH 0.5-INCH THICK INSULATION, EC MOTOR, MOTORIZED BACKDRAFT DAMPER. 2. DIRECT DRIVE PACKAGED WALL FAN, PROVIDE WITH: DISCONNECT SWITCH, EC MOTOR, MOTORIZED SHUTTER, EXPANDED METAL SHUTTER GUARD WITH INSECT SCREEN AND

3. PROVIDE WITH TEMPERATURE CONTROLLER LOREN COOK MODEL VFTC AND VARIFLOW AIR BALANCE KIT (VFABK). PROVIDE VFABK WITH 24-VOLT TRANSFORMER. INTERLOCK WITH THE EXHAUST FAN AND THE OA MOTORIZED DAMPER, CONTRACTOR TO PROVIDE ALL REQUIRED DEVICES AND INTERLOCK WIRINGS.

DEMOLITION LEGEND

EXISTING EQUIPMENT TO BE REMOVED

REMOVED

DESCRIPTION

`\HHHH} EXISTING PIPING OR EQUIPMENT TO BE OR

$\leftarrow \times \times \to \times$ PLAN DEMOLITION NOTES

AND SUPPORT TO REMAIN

- (1) EXISTING DUCTLESS SPLIT SYSTEM TO BE REPLACED DISCONNECT AND REMOVE EXISTING DUCTLESS SPLIT SYSTEM. DISCONNECT AND REMOVE EXISTING REFRIGERATION PIPING AND PIPING INSULATION. RECOVER EXISTING REFRIGERANT IN THE SYSTEM PRIOR TO DISCONNECTION. DSIPOSE RECOVERED REFRIGERANT IN ACCORDANCE WITH THE EPA REQUIREMENTS.
- 2 EXISTING ELECTRIC UNIT HEATER TO BE REPLACED. DISCONNECT AND REMOVE EXISTING ELECTRIC UNIT HEATER. EXISTING WALL BRACKET TO REMAIN
- EXISTING EXHAUST FAN TO BE REPLACED. DISCONNECT (3) AND REMOVE EXISTING EXHAUST FAN. EXISTING HANGER
- ig(4ig) EXISTING WALL MOUNTED THERMOSTAT TO BE REPLACED
- (5) EXISTING REFRIGERATION PIPING AND INSULATION TO BE REMOVED AND REPLACED. 6 EXISTING CONDENSATE DRAIN TUBING FROM UNIT TO
- EXISTING COPPER CONDENSATE DRAIN PIPING TO BE REMOVED.
- (7) EXISTING COPPER CONDENSATE DRAIN PIPING TO REMAIN
- (8) EXISTING FIRE DAMPER TO BE REPLACED
- (9) DISCONNECT AND REMOVE EXISTING EXHAUST DUCTWORK.
- EXISTING WIRELESS DUCTLESS SPLIT SYSTEM CONTROLLER TO BE REMOVED AND REPLACED
- EXISTING WALL MOUNTED PROPELLER EXHAUST FAN TO BE REPLACED. DISCONNECT AND REMOVE EXISTING EXHAUST FAN, WALL COLLAR AND EXTERIOR SCREEN.
- EXISTING 30X24 OA DAMPER TO REMOVED AND REPLACED

CONSTRUCTION NOTES

BRACKET

NUMBERED NOTES ARE APPLICABLE TO DRAWING SHEET ONLY DUCTLESS SPLIT WALL MOUNTED INDOOR UNIT. INSTALL IN ACCORDANCE WITH THE MANUFACTURER'S INSTALLATION AND CLEARANCE REQUIREMENTS. PROVIDE WITH WALL

- SIDEWALL MOUNTED CONDENSING UNIT. PROVIDE WITH MOUNTING BRACKET SUITED FOR THE NEW CONDENSING UNIT SIZE AND WEIGHT. MOUNT TOP ELEVATION OF CONDENSING UNIT 6-INCHES BELOW CONCRETE STRUCTURE. COORDINATE HEIGHT OF MOUNTING BRACKET
- GENERAL LOCATION OF CONDENSATE DRAIN PIPING FROM INDOOR UNIT CONNECTION TO EXISTING COPPER CONDENSATE DRAIN PIPING. CONTRACTOR TO PROVIDE THE REQUIRED PITCH FOR GRAVITY DRAIN CONNECTION. COORDINATE IN FIELD. NEW AND EXISTING CONDENSATE DRAIN PIPING LOCATED INSIDE THE EMR SHALL BE PROVIDED WITH 1 /2 INCH THICK INSULATION.
- STATIC FIRE DAMPER WITH INTEGRAL SLEEVE FOR USE WITH GRILLE, UL 555 CLASSIFIED, 1-1/2 HR RATING. INSTALL IN ACCORDANCE WITH MANUFACTURER'S REQUIREMENTS. ACCESS TO FIRE DAMPER SHALL BE FROM THE GRILLE. CUT , PATCH AND REPAIR WALLS AS REQUIRED. PROVIDE
- FIRESTOP AT WALL PENETRATION (5) SIDEWALL GRILLE, TITUS MODEL 350RL, 16X10
- 16X10 MOTORIZED DAMPER, EQUIVALENT TO RUSKIN MODEL CD60. PROVIDE WITH 24Y 2-POSITION DAMPER ACTUATOR. INTERLOCK WITH THERMOSTAT AND EXHAUST FAN.
- 20X20 STATIC FIRE DAMPER WITH INTEGRAL SLEEVE, UL $\overline{}$ 555 CLASSIFIED, 1-1/2 HR RATING. INSTALL IN ACCORDANCE WITH MANUFACTURER'S REQUIREMENTS. ACCESS TO FIRE DAMPER SHALL BE FROM THE DUCT MOUNTED ACCESS DOOR. CUT, PATCH AND REPAIR WALLS AS REQUIRED. PROVIDE FIRESTOP AT WALL PENETRATION
- 8 ELECTRIC UNIT HEATER. SUSPEND FROM EXISTING
- EXHAUST FAN SUPPORTED FROM EXISTING HANGER. PROVIDE WITH MOTORIZED BACKDRAFT DAMPER WITH THE SAME VOLTAGE AS THE FAN MOTOR. PROVIDE WIRE MESH SCREEN AT INTAKE
- 20X20 EXHAUST DUCTWORK. PROVIDE WITH 12X12 ACCESS
- INSULATED LIQUID AND GAS REFRIGERATION PIPING FROM INDOOR UNIT TO OUTDOOR UNIT. PROVIDE METAL JACKET FOR ALL EXPOSED PIPING ALONG THE WALL COORDINATE ROUTING IN FIELD. PROVIDE FIRESTOP

CAULKING AT RATED WALL PENETRATION

- WALL MOUNTED THERMOSTAT. INTERLOCK WITH ELECTRIC UNIT HEATER.
- TEMPERATURE CONTROLLER LOREN COOK MODEL VFTC AND VARIFLOW AIR BALANCE KIT (VFABK), OR EQUIVALENT PROVIDE VFABK WITH 24-VOLT TRANSFORMER. CONTROLLER WILL BE INTERLOCKED WITH THE EXHAUST FAN AND THE OA MOTORIZED DAMPER. PROVIDE ALL REQUIRED DEVICES AND INTERLOCK WIRINGS.
- $\langle _{14}
 angle$ wired wall mounted ductless split system. CONTROLLER. PROVIDE WITH INTERLOCK WIRING
- SIDEWALL MOUNTED CONDENSING UNIT. PROVIDE WITH MOUNTING BRACKET SUITED FOR THE NEW CONDENSING UNIT SIZE AND WEIGHT. MOUNT TOP ELEVATION OF CONDENSING UNIT 6-INCHES BELOW CONCRETE STRUCTURE. COORDINATE HEIGHT OF MOUNTING BRACKET
- $\langle 16 \rangle$ PROVIDE NEW PLENUM TO ACCOMMODATE NEW 30X24 OUTSIDE AIR DAMPER. COORDINATE IN FIELD. PROVIDE OUTSIDE AIR MOTORIZED DAMPER WITH 115V ACTUATOR.
- NEW DIRECT DRIVE PACKAGED WALL FAN. INSTALL IN ACCORDANCE WITH MANUFACTURER'S REQUIREMENTS. PROVIDE WITH 115 V MOTORIZED SHUTTER INTERLOCKED WITH THE EXHAUST FAN. INSTALL SHUTTER, SHUTTER GUARD AND WEATHERHOOD IN ACCORDANCE WITH MANUFACTURER'S INSTALLATION AND CLEARANCE REQUIREMENTS.
- SIDEWALL MOUNTED CONDENSING UNIT. PROVIDE WITH $\langle ^{18} \rangle$ mounting bracket suited for the New Condensing UNIT SIZE AND WEIGHT. MOUNT CONDENSING UNIT BELOW EXTERIOR STAIRS. COORDINATE HEIGHT OF MOUNTING BRACKET IN FIELD.
- INSULATED LIQUID AND GAS REFRIGERATION PIPING ROUTED EXPOSED ALONG EXTERIOR WALL TO CONDENSING UNIT BELOW STAIRS. COORDINATE EXACT ROUTING IN FIELD

SYMBOL LEGEND

(NOT ALL SYMBOLS ARE USED)

REFERENCE, NUMBER

EXISTING PIPING OR

INDICATES NOTE

EXISTING PIPING OR EQUIPMENT

FLEXIBLE DUCT

POINT OF CONNECTION

MOTORIZED DAMPER

FIRE DAMPER WITH

HERMOSTAT/SENSOR

PIPE ELBOW, TURNED DOWN

ACCESS DOOR

PIPE COUPLING

ABBREVIATIONS

(NOT ALL SYMBOLS ARE USED)

AC- # INDOOR AIR CONDITIONING UNIT

AD ACCESS DOOR

CAP CAPACITY

DB DRY BULB

EX EXISTING

EXH EXHAUST

FD FIRE DAMPER

FEET

INCHES

1000 BTU'S

MFS MAXIMUM FUSE SIZE

OUTSIDE AIR

SP STATIC PRESSURE

SQ FT SQUARE FOOT (AREA)

SWR SIDE WALL REGISTER

TEMP TEMPERATURE

WITH

WMS WIRE MESH SCREEN

TOT TOTAL

TYP TYPICAL

WB WET BULB

WT WEIGHT (LBS)

THERMOSTAT

MINIMUM

PHASE

RM ROOM

MCA MINIMUM CIRCUIT AMPACITY

MOTORIZED DAMPER

OAT OUTDOOR AIR TEMPERATURE

RPM REVOLUTIONS PER MINUTE

SINGLE POLE SWITCH

W/THERMAL OVERLOAD

TEMPERATURE DIFFERENCE

HTG HEATING

KW KILOWATT

MIN

OA

PH

TD

DD DIRECT DRIVE

EF-# EXHAUST FAN

AFF ABOVE FINISHED FLOOR

CFM CUBIC FEET PER MINUTE

EAT ENTERING AIR TEMPERATURE

EER ENERGY EFFICIENCY RATIO

EMR ELEVATOR MACHINE ROOM

DEGREES FAHRENHEIT

EUH-# ELECTRIC UNIT HEATER

FLA FULL LOAD AMPERES

GC GENERAL CONTRACTOR

LEAVING AIR TEMPERATURE

HORSEPOWER

CUH CABINET UNIT HEATER

CONNECTION

TRANSITION

FIRE DAMPER

---MD

- THE INTENT OF THESE CONTRACT DOCUMENTS IS FOR THE CONTRACTOR TO FURNISH AND INSTALL COMPLETE HYAC SYSTEMS. ALL SYSTEMS SHALL BE COMPLETE IN ALL RESPECTS. OPERATING, TESTED, ADJUSTED, APPROVED BY THE AUTHORITIES HAVING JURISDICTION AND READY FOR BENEFICIAL USE BY THE OWNER.
- THE CONTRACTOR SHALL OBTAIN AND REVIEW ALL CONTRACT DOCUMENTS, INCLUDING PROJECT MANUAL, PLANS AND SPECIFICATIONS OF ALL TRADES BEFORE SUBMITTING BID. REFER TO SPECIFICATIONS, PROJECT MANUAL AND PLANS, INCLUDING ALL EQUIPMENT SCHEDULES FOR MECHANICAL AND ELECTRICAL INFORMATION. CONTRACTOR SHALL WALK THROUGH BUILDING PRIOR TO SUBMITTING BID.
- 3. ALL OF THE CONTRACT DRAWINGS AND SPECIFICATIONS ARE COMPLEMENTARY TO FORM A TOTAL DESIGN PACKAGE. IT IS THE RESPONSIBILITY OF THE GENERAL CONTRACTOR/CONSTRUCTION MANAGER TO DETERMINE WHICH TRADE CONTRACTOR IS RESPONSIBLE FOR VARIOUS PORTIONS OF THE WORK.
- 4. ALL WORK AND ACTION DEPICTED AND DESCRIBED IN CONTRACT DOCUMENTS SHALL BE PERFORMED BY THE CONTRACTOR UNLESS SPECIFICALLY NOTED OTHERWISE.
- 5. THE DRAWINGS ARE DIAGRAMMATIC AND INDICATE THE GENERAL ARRANGEMENT OF SYSTEMS AND WORK INCLUDED IN THE CONTRACT. THE CONTRACTOR SHALL COORDINATE LOCATIONS OF EQUIPMENT WITH ALL TRADES BEFORE STARTING CONSTRUCTION. ANY MODIFICATIONS TO THE EQUIPMENT LAYOUT REQUIRED FOR INSTALLATION ARE TO BE PERFORMED AT NO ADDITIONAL COST TO THE OWNER.
- 6. WHEN CONFLICTS OCCUR BETWEEN THE DRAWINGS AND/OR SPECIFICATIONS IT SHALL BE BROUGHT TO THE ATTENTION OF THE ENGINEER. THE CONTRACTOR SHALL CARRY AS PART OF THE BID THE LARGER QUANTITY AND/OR MORE EXPENSIVE ITEM(S).
- 7. ALL WORK SHALL BE PERFORMED IN ACCORDANCE WITH THE REQUIREMENTS OF THE CONTRACT GENERAL CONDITIONS AND WITH THE PROVISIONS OF ALL APPLICABLE LOCAL, STATE, AND FEDERAL CODES AND LAWS.
- 8. ALL WORK AND ACTION DEPICTED AND DESCRIBED SHALL BE PERFORMED BY THE CONTRACTOR. ITEMS AND SERVICES NOT SHOWN ON DRAWINGS OR SPECIFICATIONS BUT ARE REQUIRED TO RENDER THE WORK COMPLETE AND READY FOR OPERATION, SHALL BE PROVIDED WITHOUT ADDITIONAL
- 9. OBTAIN AND PAY FOR ALL REQUIRED PERMITS AND
- 10. PROVIDE SUPPORT/BRACING OF EQUIPMENT AND BUILDING SERVICES AS REQUIRED BY THE BUILDING CODE.
- REPAIR AND REPLACE AT NO COST TO OWNER ALL EQUIPMENT AND MATERIALS DAMAGED DURING CONSTRUCTION.
- 12. ALL EQUIPMENT, MATERIALS AND RELATED SYSTEMS COMPONENTS SHALL BE NEW UNLESS SPECIFICALLY NOTED OTHERWISE.
- 13. ALL EQUIPMENT, PIPING, DUCTWORK SHALL BE SUPPORTED AS DETAILED, SPECIFIED AND REQUIRED TO PROVIDE A VIBRATION FREE INSTALLATION.
- 14 CONTRACTORS SHALL PROVIDE ALL REQUIRED SLEEVES AND SEALS FOR PIPES OR CONDUIT PENETRATING WALLS OR FLOOR SLABS WITH FIRE STOPPING SEALANT WHERE
- PROVIDE VIBRATION ISOLATION FOR ALL MECHANICAL
- 16. INSTALL COMPLETE OPERATING SYSTEMS. PROVIDE ALL COMPONENTS, DEVICES, CONTROLS, RELAYS, TRANSFORMERS, ETC., WHETHER INDICATED OR NOT, FOR COMPLETE SYSTEMS AS INTENDED BY THE CONSTRUCTION DOCUMENTS.
- CEILINGS SHALL BE SEALED USING U.L. LISTED METHODS APPROPRIATE FOR INDICATED RATING

17. ALL PENETRATIONS THRU RATED WALLS, FLOORS &

- 18. PROVIDE ACCESS DOORS/PANELS FOR INSTALLATION IN WALLS AND/OR CEILINGS, WHERE REQUIRED, TO SERVICE
- 19. PROVIDE ACCESS DOORS/PANELS FOR INSTALLATION IN WALLS AND/OR CEILINGS, WHERE REQUIRED, TO SERVICE

ALTERATION WORK AND DEMOLITION

- 1. THE EXISTING CONDITIONS REPRESENTED HEREON ARE BASED ON GENERAL LOCATIONS OF EXISTING COMPONENTS IN THE FIELD AND ARE SHOWN ON THIS DRAWING FOR CONTRACTORS REFERENCE ONLY. ACTUAL LOCATION AND SIZE OF EQUIPMENT AND DUCTWORK AND EXTENT OF DUCTWORK ROUTING, PIPING AND EXTENT OF PIPING LENGTH AND ROUTING AND UTILITIES MAY VARY IN FIELD. MECHANICAL CONTRACTOR SHALL VERIFY LOCATIONS IN FIELD AND MAKE ALLOWANCE IN BID FOR LOCATIONS AND ARRANGEMENTS OTHER THAN SHOWN.
- 2. THE DEMOLITION NOTES ARE FOR DESCRIPTIVE GUIDE ONLY. THE CONTRACTOR SHALL BE RESPONSIBLE FOR THE REMOVAL OF ALL ITEMS WHETHER OR NOT INDICATED AND/ OR NOTED ON THE DRAWINGS. INCLUSION OF THESE EXISTING CONDITIONS HEREON SHALL IN NO WAY ALLEVIATE THE CONTRACTOR(S) OF HIS RESPONSIBILITY TO VISIT THE SITE TO VERIFY ALL EXISTING CONDITIONS.
- REMOVE, MODIFY AND REPLACE EXISTING SYSTEMS AS REQUIRED FOR INSTALLATION OF NEW HVAC SYSTEMS.
- 4. IT IS NOT THE INTENT OF THESE DRAWINGS TO SHOW EVERY PIECE OF EQUIPMENT, PIPING OR CONDUIT TO BE REMOVED. EQUIPMENT NOT BEING USED SHALL BE REMOVED INCLUDING ALL ASSOCIATED HANGERS, SUPPORTS, PIPES, DUCTS, CONDUITS, WIRES AND CONTROLS BACK TO THE POINT OF
- 5. ALL WASTE MATERIALS AND EQUIPMENT SHALL BE REMOVED FROM SITE AND SHALL BE LEGALLY DISPOSED BY THE CONTRACTOR.
- NO EQUIPMENT, PIPING OR CONDUIT SHALL BE ABANDONED IN PLACE UNLESS SPECIFICALLY NOTED.
- 7 NO WORK SHALL BE LEFT INCOMPLETE NOR ANY HAZARDOUS SITUATIONS CREATED WHICH WILL AFFECT THE LIFE OR SAFETY OF THE PUBLIC AND/OR BUILDING OCCUPANTS. AT NO TIME SHALL THE WORK INTERFERE WITH OR CUTOFF ANY OF THE EXISTING SERVICES WITHOUT THE OWNER'S WRITTEN PERMISSION.
- 8 COORDINATE SHUTDOWN OF EXISTING SERVICES WITH OWNER'S MAINTENANCE PERSONNEL. NO WORK SHALL TAKE PLACE UNTIL DOING SO.
- 9. THE CONTRACTOR IS RESPONSIBLE FOR COORDINATING HIS WORK WITH ALL TRADES.
- 10. PIPING AND DUCT WORK LAYOUTS AS INDICATED ON THE DRAWINGS ARE DIAGRAMATIC; PROVIDE ADDITIONAL TRANSITIONS AND OFFSETS AS REQUIRED FOR COORDINATION WITH BUILDING CONSTRUCTION AND THE WOR OF OTHER TRADES.
- 11. PROVIDE FIRE DAMPERS AT DUCT PENETRATIONS OF FIRE RATED PARTITIONS.
- 12. MAINTAIN MANUFACTURER'S RECOMMENDED MINIMUM CLEARANCES FOR INSTALLATION OF EQUIPMENT.
- 13 INSTALL COMPLETE OPERATING SYSTEMS. PROVIDE ALL COMPONENTS, DEVICES, CONTROLS, RELAYS, TRANSFORMERS, ETC., WHETHER INDICATED OR NOT, FOR COMPLETE SYSTEMS AS INTENDED BY THE CONSTRUCTION DOCUMENTS.
- 14 THE TEMPERATURE CONTROL SYSTEM SHALL BE COMPLETE IN ALL REGARDS, TESTED AND CAPABLE OF ACHIEVING THE SEQUENCES OF OPERATION. ALL DEVICES SHALL BE UNDER SYSTEM CONTROL. ALL SPACES SHALL BE THERMOSTATICALLY CONTROLLED WHETHER OR NOT A THERMOSTAT, SENSOR OR CONTROLLER IS INDICATED.

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NO. DATE BY

REVISIONS DRAWING TITLE TEMPLE STREET

GARAGE GROUND FLOOR AND ROOF EMR PLANS

DRAWING NO. TS-M-1

SCALE: AS NOTED DATE: JULY 2025 PROJECT NO. 20-20176.00-2 NHPA NO. 21-011 DESIGN DRAWN CH'KI AMG | AMG | RRB

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